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STATE OF NORTH CAROLINA DIVISION OF HIGHWAYS

WAKE COUNTY

 $\mathbb{N.C.}$ U-5315A/U-5315B $\mathbb{ITS-1}$ U-5315A 45429.1.F2 STPDA-0503(19) U_5315A 45429.2.2 R/W, UTILITIES STPDA-0540(38) U-5315B 45429.1.F3 STPDA-0503(19) STPDA-0540(39) R/W, UTILITIES U-5315B 45429.2.3 U-5315A&B 45429.3.3 STPDA-0540(39) CONST. U-5315B 45429.5.TA1 TURNPIKE CONST. U-5315B 45429.5.TA3 TURNPIKE ROW

LOCATION: MORRISVILLE PARKWAY EXTENSION AND NC 540 INTERCHANGE FROM WEST OF HIGHCROFT DRIVE TO EAST OF MILLS PARK DRIVE IN CARY TYPE OF WORK: COMMUNICATIONS CABLE, CONDUIT ROUTING, CLOSED CIRCUIT TELEVISION CAMERAS AND MICROWAVE VEHICLE DETECTORS

N.T.S. END PROJECT U-5315A -L- Sta. 85+00.00TO NC 55

TO NC 55

MORRISVILLE PARKWAY

A-MORRISVILLE PARKWAY *MVD*-76 TOLL SITE AET T16 MVD-75LPB_ BEGIN PROJECT U-5315B END PROJECT U-5315B -L- Sta. 56 + 95.00BEGIN PROJECT U-5315A -L- Sta. 76+00.00CCTV-8ATOLL SITE AET T15 MVD-74MVD-73CCTV-8 **DOCUMENT NOT CONSIDERED FINAL UNLESS ALL SIGNATURES COMPLETED**

GRAPHIC SCALES

PLANS

Begin Project

SHEET ITS-1 SHEET IT-1A SHEET IT-2A THRU ITS-2P SHEET ITS-3A THRU ITS-3D

End Project

VICINITY MAP

SHEET ITS-4 THRU ITS-8

SHEET ITS-9 THRU ITS-15

TITLE SHEET CONSTRUCTION NOTES

INDEX OF SHEETS

STANDARD ITS & AET DETAILS TOLL SITE PAD, JUNCTION BOX, AND CONDUIT DETAILS COMMUNICATIONS CABLE AND CONDUIT ROUTING SPLICE DETAILS

PREPARED IN THE OFFICE OF: RUMMEL, KLEPPER & KAHL, LLP 900 RIDGEFIELD DRIVE, SUITE 350 RALEIGH, NORTH CAROLINA 27609 NC LICENSE NO. F-0112

FOR NORTH CAROLINA DEPARTMENT OF TRANSPORTATION

2012 STANDARD SPECIFICATIONS

C. BYRON HOLDEN, P.E. PROJECT ENGINEER

DAVID SEARS, P.E. LETTING DATE: PROJECT DESIGN ENGINEER **DECEMBER 19, 2017**

NCDOT CONTACTS: NORTH CAROLINA TURNPIKE AUTHORITY DENNIS JERNIGAN, P.E.

TRANSPORTATION AND MOBILITY INTELLIGENT TRANSPORTATION SYSTEMS SECTION SHERRY YOW



C. Byron Holden —66B7E2D**\$**CR€BK49A.TURE DATE



12/10/2017

750 N. Greenfield Pkwy., Garner, NC 27529

U-5315 A&B ITS-1A

INSTALL RS-485 CABLE INSTALL SIZE 350 MCM 4-WIRE COPPER FEEDER CONDUCTORS INSTALL 3-WIRE COPPER FEEDER CONDUCTORS INSTALL SMFO CABLE INSTALL MMFO CABLE INSTALL FIBER OPTIC DROP CABLE INSTALL TRACER WIRE **TRENCH** INSTALL PVC CONDUIT (10) INSTALL RIGID, GALVANIZED STEEL CONDUIT INSTALL RIGID, GALVANIZED STEEL RISER WITH WEATHERHEAD (12 INSTALL RIGID, GALVANIZED STEEL RISER WITH FIBER OPTIC CABLE SEAL (13 INSTALL OUTER-DUCT POLYETHYLENE CONDUIT 14 INSTALL POLYETHYLENE CONDUIT 15 DIRECTIONAL DRILL CONDUIT 16) BORE AND JACK CONDUIT INSTALL CABLE(S) IN EXISTING CONDUIT INSTALL CABLE(S) IN NEW CONDUIT INSTALL CABLE(S) IN EXISTING RISER INSTALL CABLE(S) IN NEW RISER INSTALL CABLE(S) IN EXISTING CONDUIT STUBOUTS INSTALL NEW CONDUIT INTO EXISTING CABINET BASE (22)(USE EXISTING CONDUIT STUB-OUTS WHEN AVAILABLE) INSTALL NEW RISER INTO EXISTING CABINET BASE (23)(USE EXISTING CONDUIT STUB-OUTS WHEN AVAILABLE) INSTALL NEW CONDUIT INTO NEW POLE MOUNTED CABINET INSTALL NEW RISER INTO EXISTING POLE MOUNTED CABINET TERMINATE COMMUNICATIONS CABLE ON EXISTING TELEMETRY (26) INTERFACE PANEL IN TRAFFIC SIGNAL CONTROLLER CABINET INSTALL NEW TELEMETRY INTERFACE PANEL IN **(27)** TRAFFIC SIGNAL CONTROLLER CABINET INSTALL INTERCONNECT CENTER, PATCH PANEL, JUMPERS, AND FUSION SPLICE CABLE IN CABINET OR RACK IN VAULT INSTALL UNDERGROUND SPLICE ENCLOSURE INSTALL AERIAL SPLICE ENCLOSURE INSTALL POLE MOUNTED SPLICE CABINET INSTALL BASE MOUNTED SPLICE CABINET REMOVE EXISTING SPLICE CABINET INSTALL CABINET FOUNDATION

35	REMOVE EXISTING CABINET FOUNDATION
36	INSTALL CCTV CAMERA ASSEMBLY
37	INSTALL CCTV CAMERA WOOD POLE
38	INSTALL CCTV CAMERA METAL POLE AND FOUNDATION
39	INSTALL JUNCTION BOX WITH 18" REINFORCED CONCRETE COLLA 4" THICK MIN.
40	INSTALL OVERSIZED JUNCTION BOX WITH 18" REINFORCED CONC
41	INSTALL OVERSIZED SPLICE BOX WITH 18" REINFORCED CONCRETE COLLAR 4" THICK MIN.
42	INSTALL WOOD POLE
43	REMOVE EXISTING WOOD POLE
44	INSTALL AERIAL GUY ASSEMBLY
45	INSTALL STANDARD GUY ASSEMBLY
46	INSTALL SIDEWALK GUY ASSEMBLY
47	INSTALL MESSENGER CABLE
48	REMOVE EXISTING COMMUNICATIONS CABLE AND MESSENGER CA
49	REMOVE EXISTING COMMUNICATIONS CABLE
50	INSTALL TELEPHONE SERVICE
51	INSTALL CABLE STORAGE RACKS (SNOW SHOES) AND STORE 100 FEET OF CABLE
52	INSTALL DELINEATOR MARKER
53	STORE 50 FEET OF EACH COMMUNICATIONS CABLE
54	LASH CABLE(S) TO EXISTING SIGNAL/COMMUNICATIONS CABLE
55	LASH CABLE(S) TO EXISTING MESSENGER CABLE
56	LASH CABLE(S) TO NEW MESSENGER CABLE
57	MODIFY EXISTING ELECTRICAL SERVICE
58	INSTALL NEW ELECTRICAL SERVICE
59	INSTALL ETHERNET SWITCH
60	INSTALL MVD ASSEMBLY
61	INSTALL MVD METAL POLE AND FOUNDATION
62	INSTALL EQUIPMENT CABINET
63	INSTALL MVD TERMINAL SERVER ASSEMBLY
64	REMOVE EXISTING JUNCTION BOXES

CONTRACTOR SHALL INSTALL AND UTILIZE CONDUITS AS SHOWN.

CONDUIT USE

BLUE TOLL FOC
WHITE TOLL SPARE
BLACK ITS FOC
ORANGE ITS SPARE



N/A

LEGEND EXISTING COMMUNICATIONS CABLE EXISTING COMMUNICATIONS CABLE NEW CONDUIT ______ EXISTING CONDUIT NEW DIRECTIONAL DRILLED CONDUIT NEW OVERSIZED, HEAVY DUTY JUNCTION BOX WITH 18" REINFORCED CONCRETE APRON 4" THICK MIN. NEW OVERSIZED, HEAVY DUTY SPLICE BOX WITH 18" REINFORCED CONCRETE APRON 4" THICK MIN. NEW TOLL SITE COMMUNICATIONS GROUND BOX WITH 18" REINFORCED CONCRETE APRON 4" THICK MIN. NEW TOLL SITE POWER GROUND BOX WITH 18" REINFORCED CONCRETE APRON 4" THICK MIN. NEW TOLL SITE LOOP SPLICE BOX WITH 18" REINFORCED CONCRETE APRON 4" THICK MIN. EXISTING OVERSIZED, HEAVY DUTY JUNCTION BOX NEW SPLICE ENCLOSURE NEW METAL POLE EXISTING METAL POLE NEW CCTV CAMERA ASSEMBLY EXISTING CCTV CAMERA ASSEMBLY NEW MICROWAVE DETECTOR (MVD) ASSEMBLY EXISTING MICROWAVE DETECTOR (MVD) ASSEMBLY NEW RWIS ASSEMBLY EXISTING RWIS ASSEMBLY EXISTING FIELD EQUIPMENT CABINET NEW FIELD EQUIPMENT CABINET

CONSTRUCTION NOTE SYMBOLOGY KEY

ABBREVIATIONS

CLOSED-CIRCUIT TELEVISION

ALL-ELECTRONIC TOLLING

INTELLIGENT TRANSPORTATION SYSTEM


MICROWAVE VEHICLE DETECTION


(XX) INDICATES NUMBER OF CABLES, LOOPS, ETC.

INDICATES NUMBER OF FIBERS PER CABLE, TWISTED PAIRS PER CABLE, ETC.

XX INDICATES NUMBER OF RISER(S)/CONDUIT(S)

XX INDICATES DIAMETER OF RISER(S)/CONDUIT(S) (INCH)

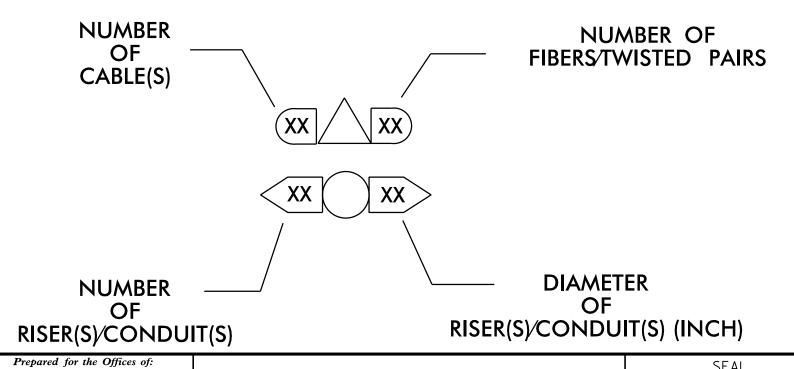

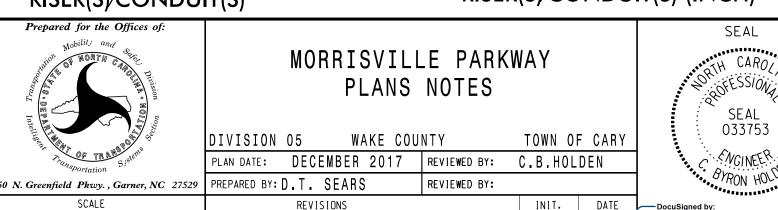


Docusigned by:

C. Byron Holden 12/10/2017

GGB7 FIGAN ATHURE DATE

CADD FILE NAME: U3515_ITS_PSH01a.DG

PROJECT REFERENCE NO. SHEET NO. ITS-2A U-5315 A&B

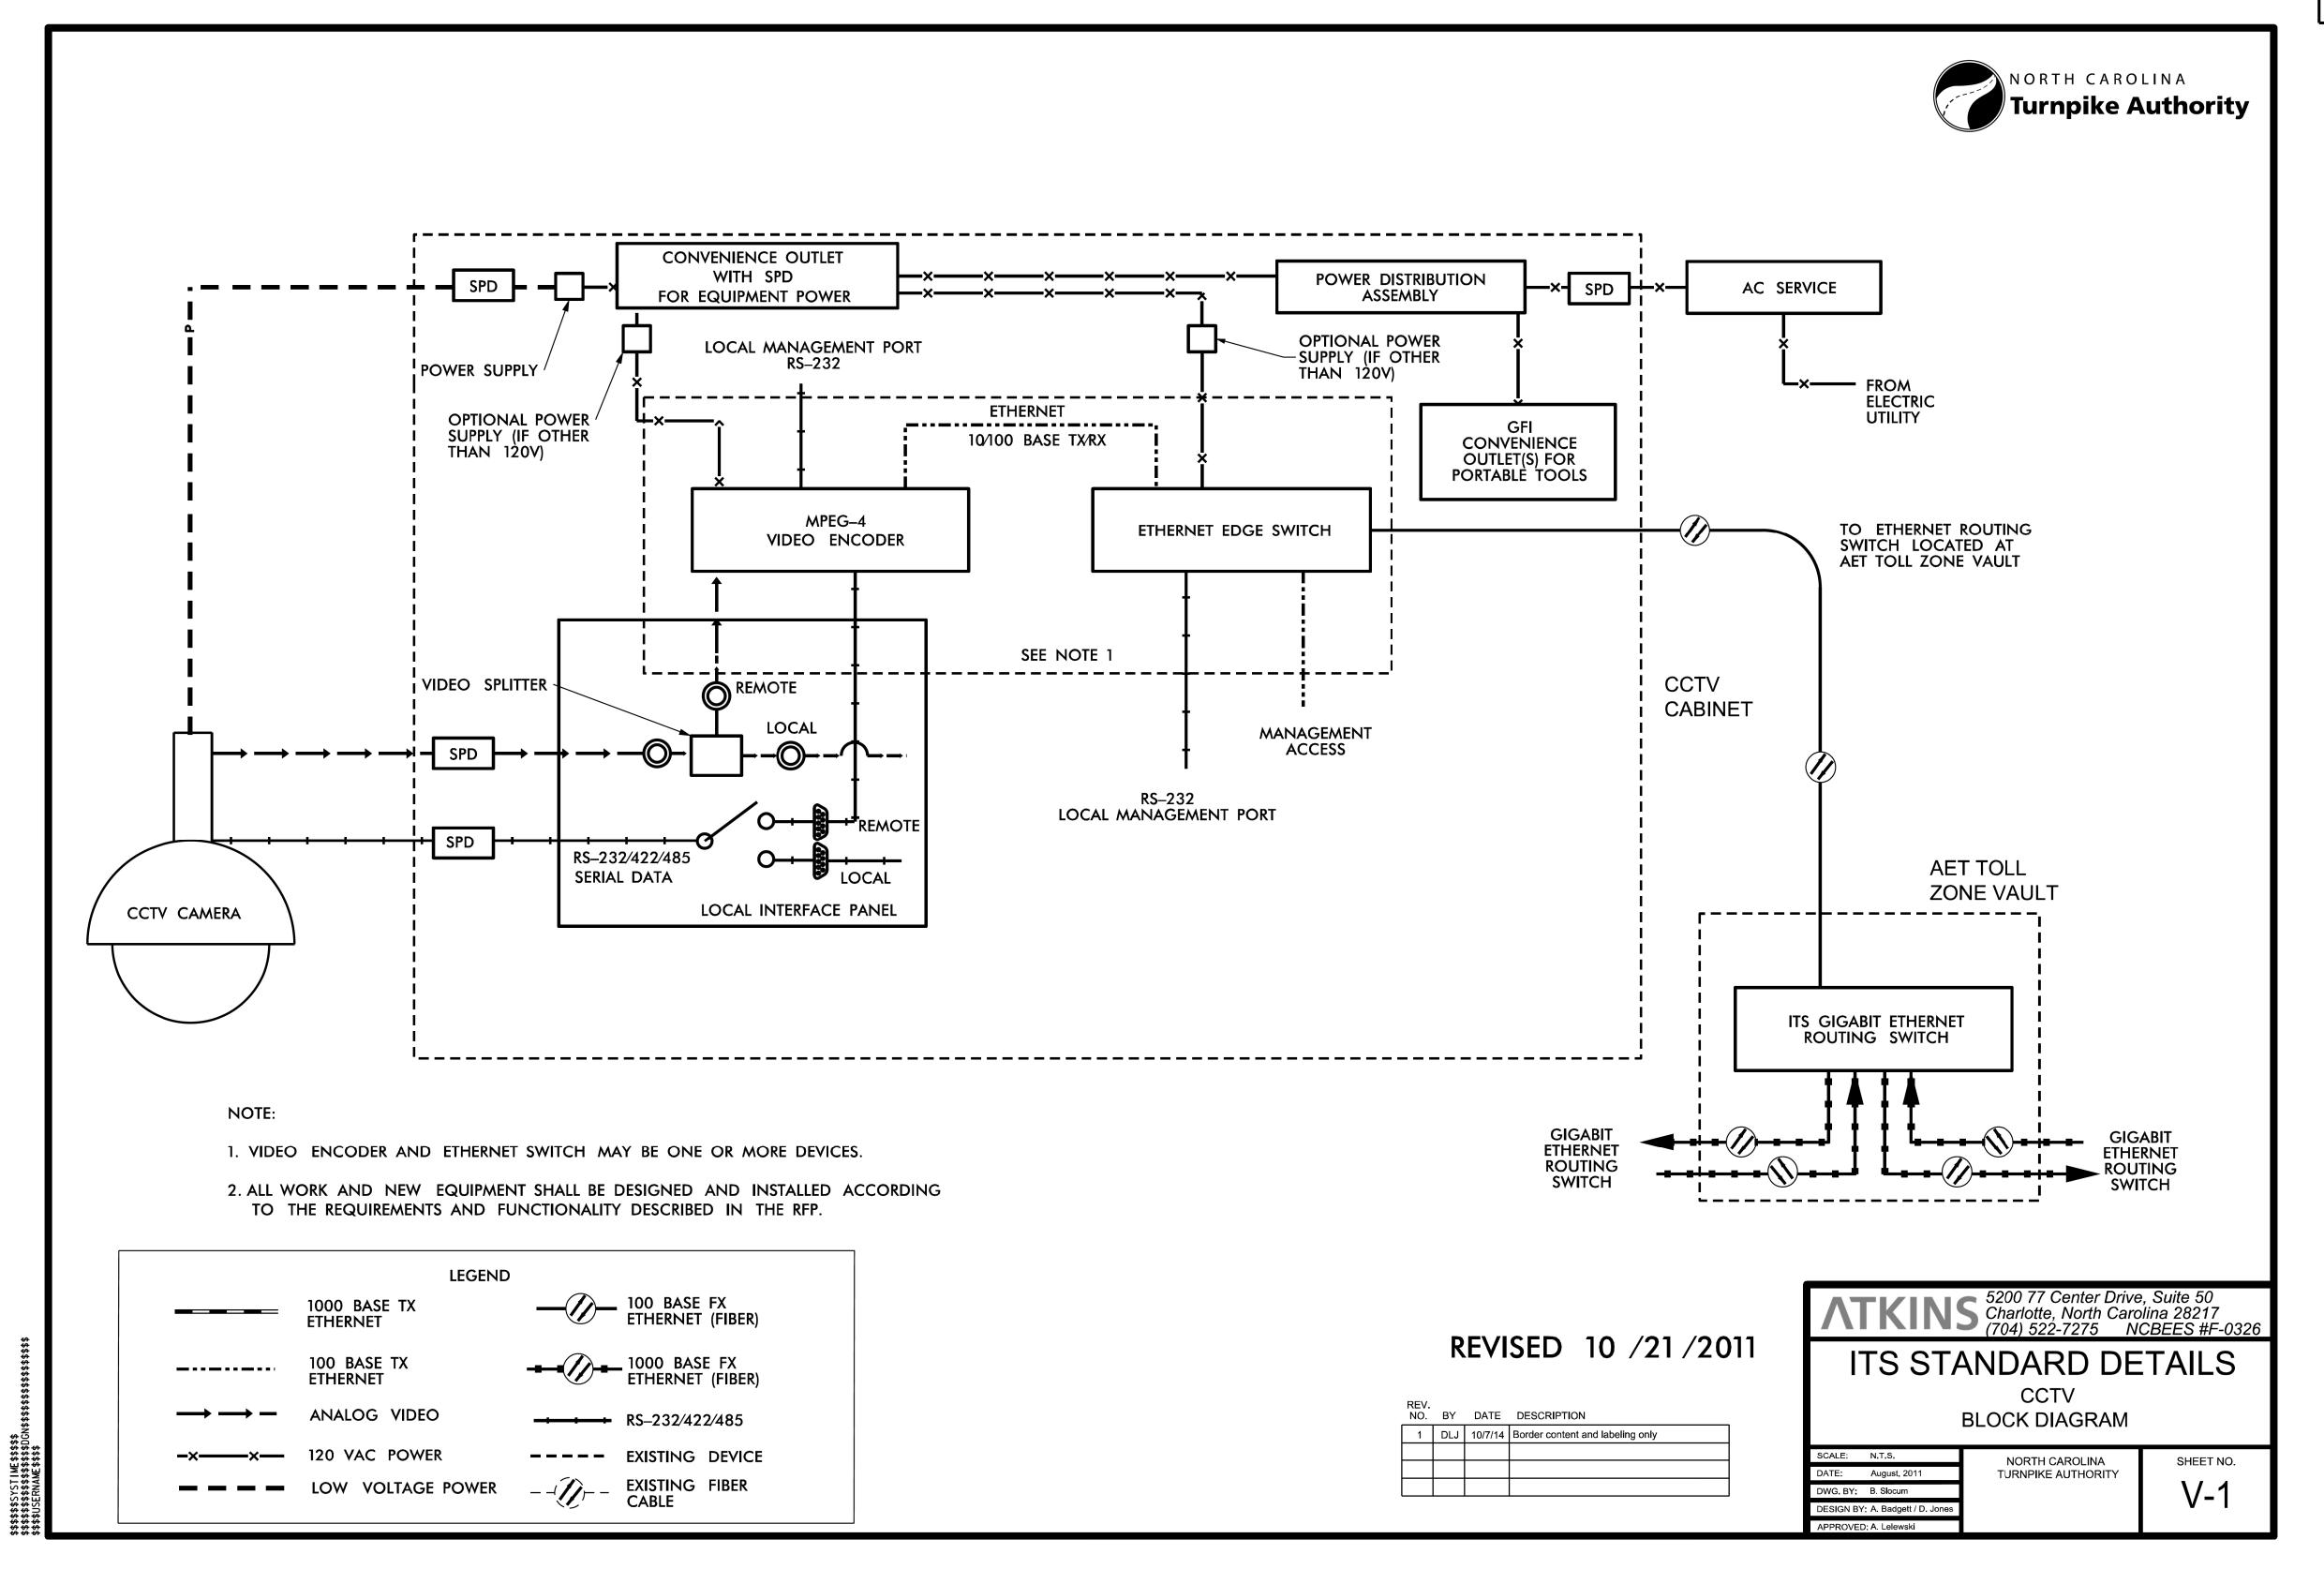

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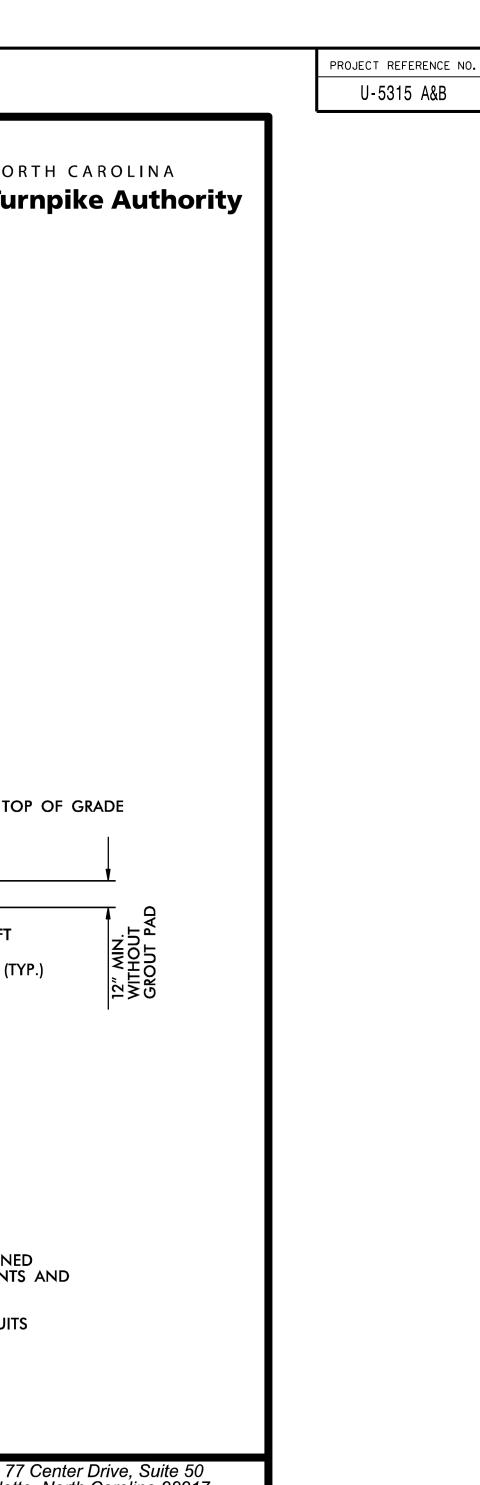



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NORTH CAROLINA TURNPIKE AUTHORITY ITS STANDARD DETAIL

DIVISION 05 WAKE COUNTY TOWN OF CARY PLAN DATE: NOVEMBER 2017 REVIEWED BY: C.B. HOLDEN PREPARED BY: D.T. SEARS REVIEWED BY: REVISIONS INIT. DATE

CADD Filename: U5315_ITS_standarddetails.dg





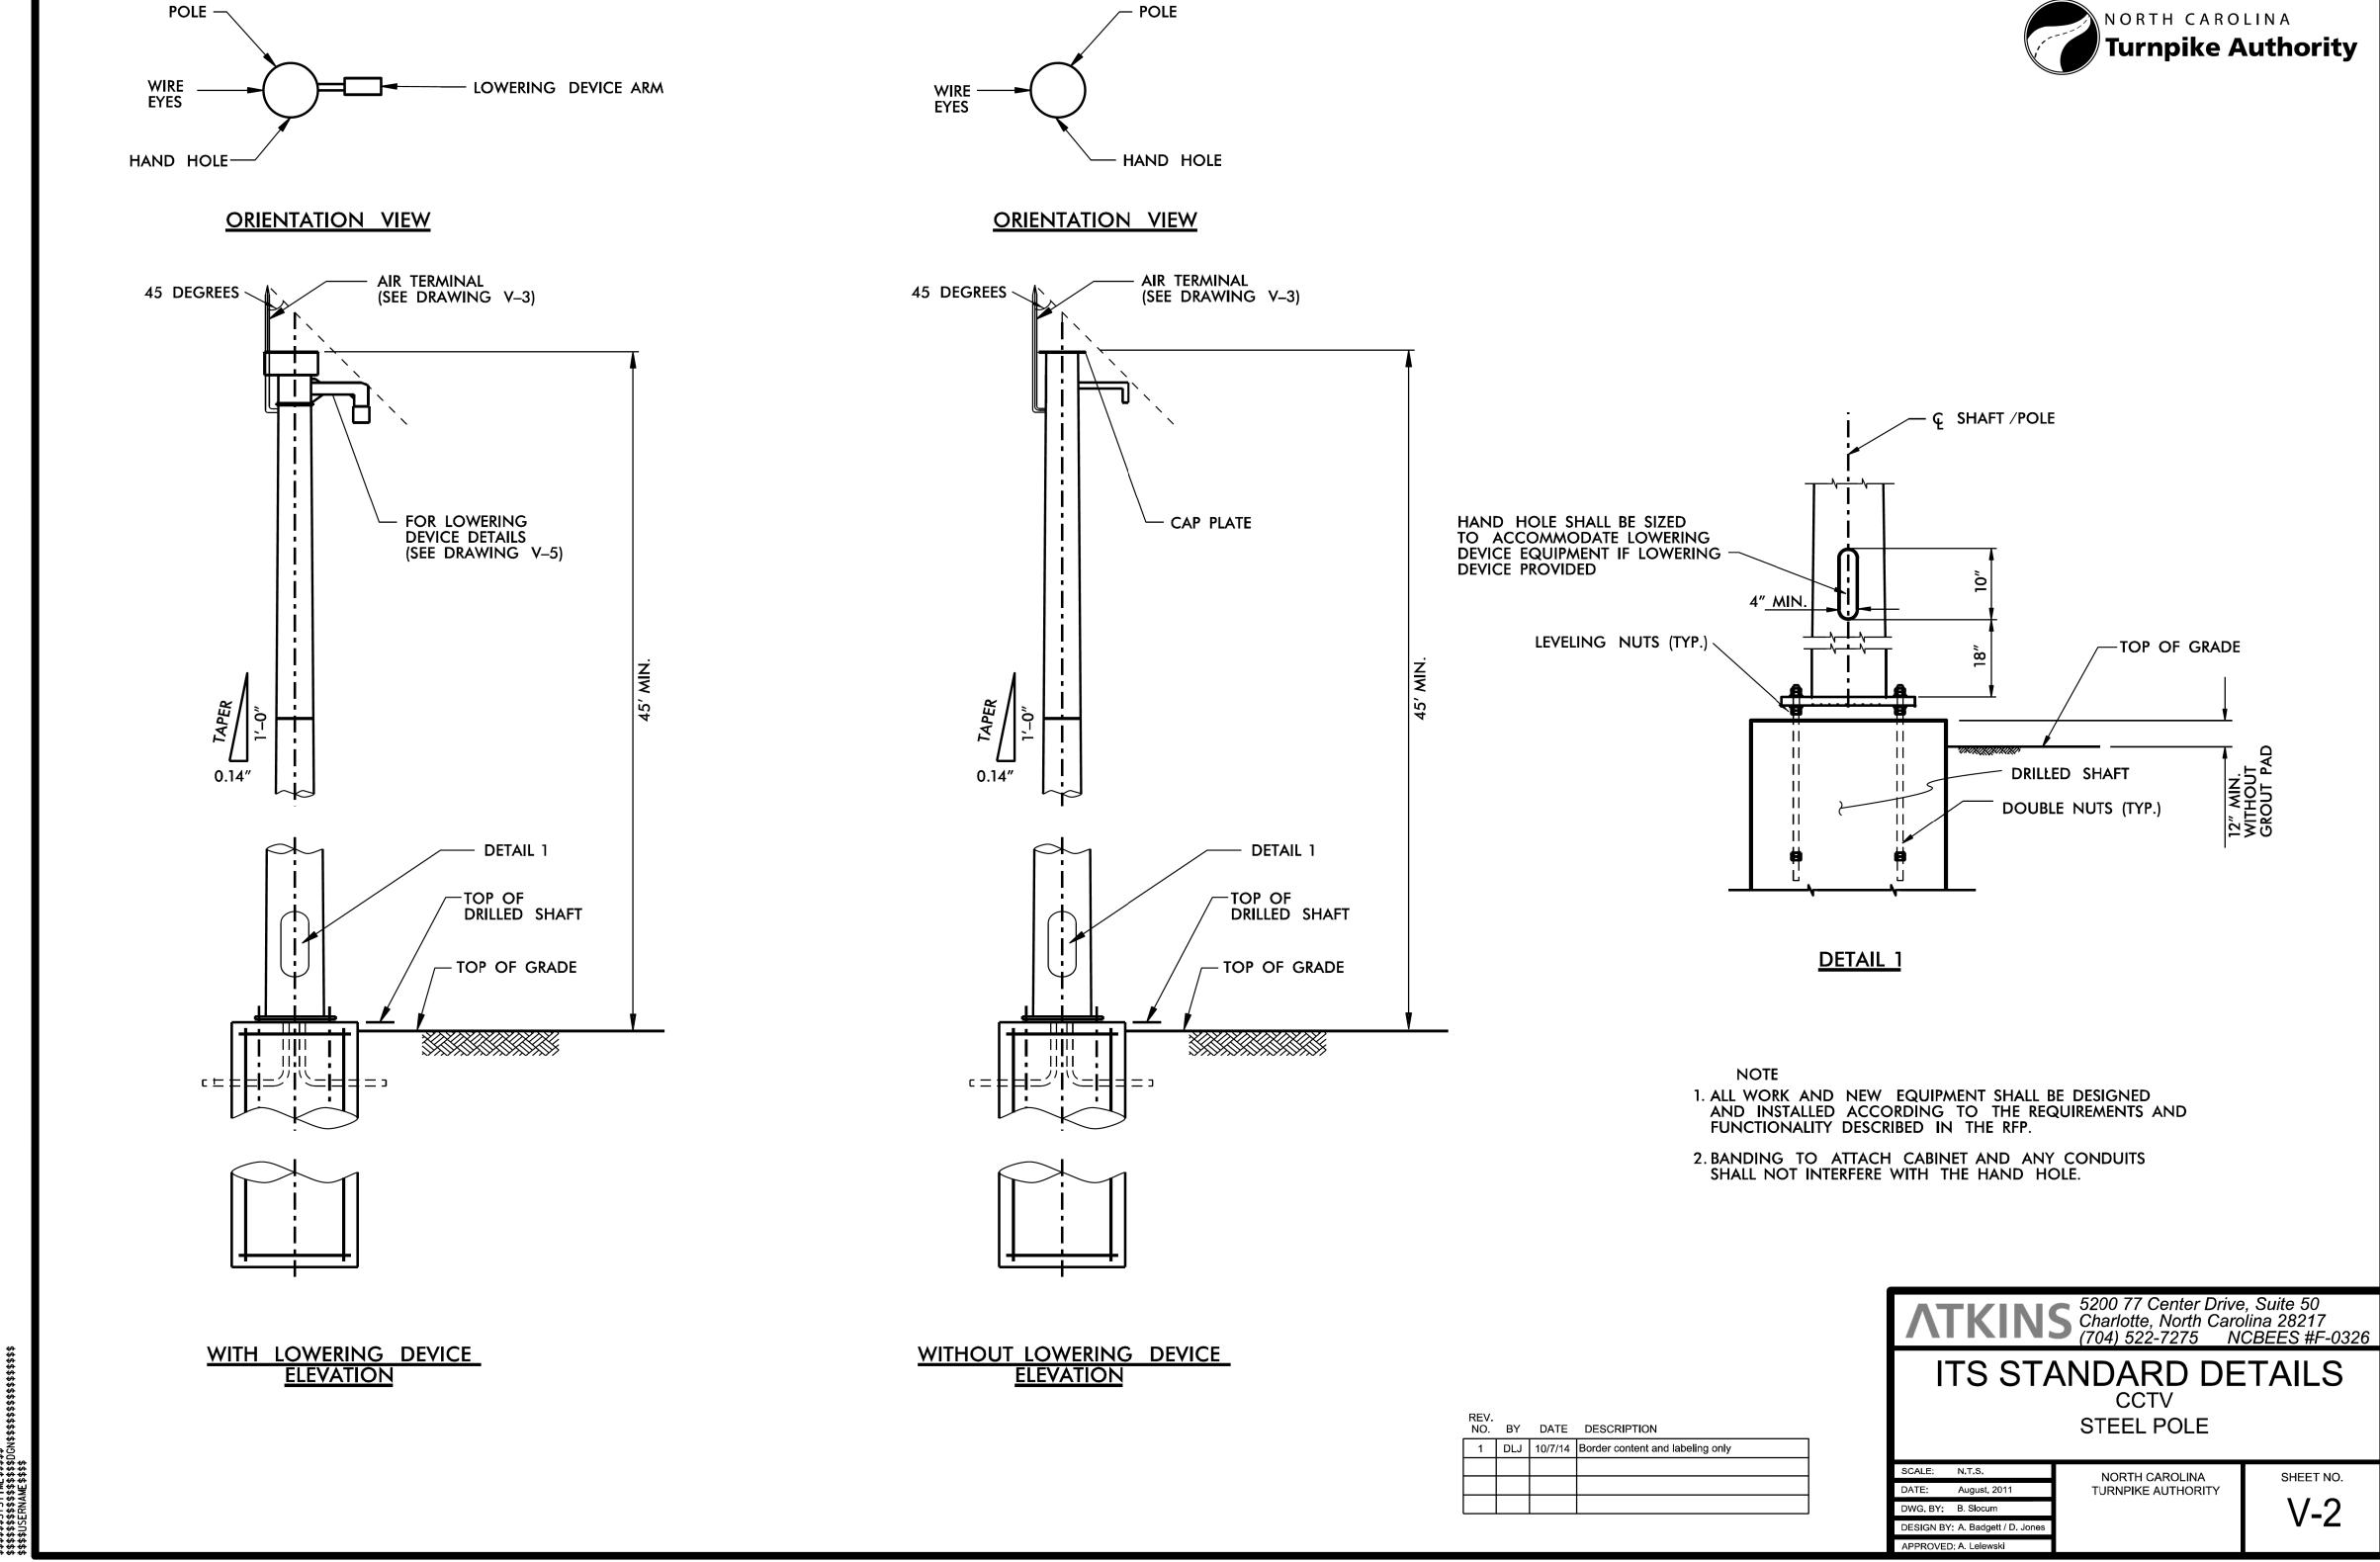



Prepared for the Offices of:			
Mobility and Control of Month Control of		D:	
Transportation SJSCO			
750 N. Greenfield Pkwy., Garner, NC 27529			
	SCALE		

N/A


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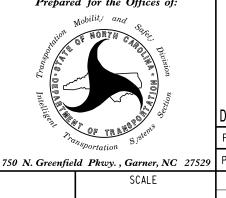
ITS-2B

PROJECT REFERENCE NO. SHEET NO U-5315 A&B ITS-2C



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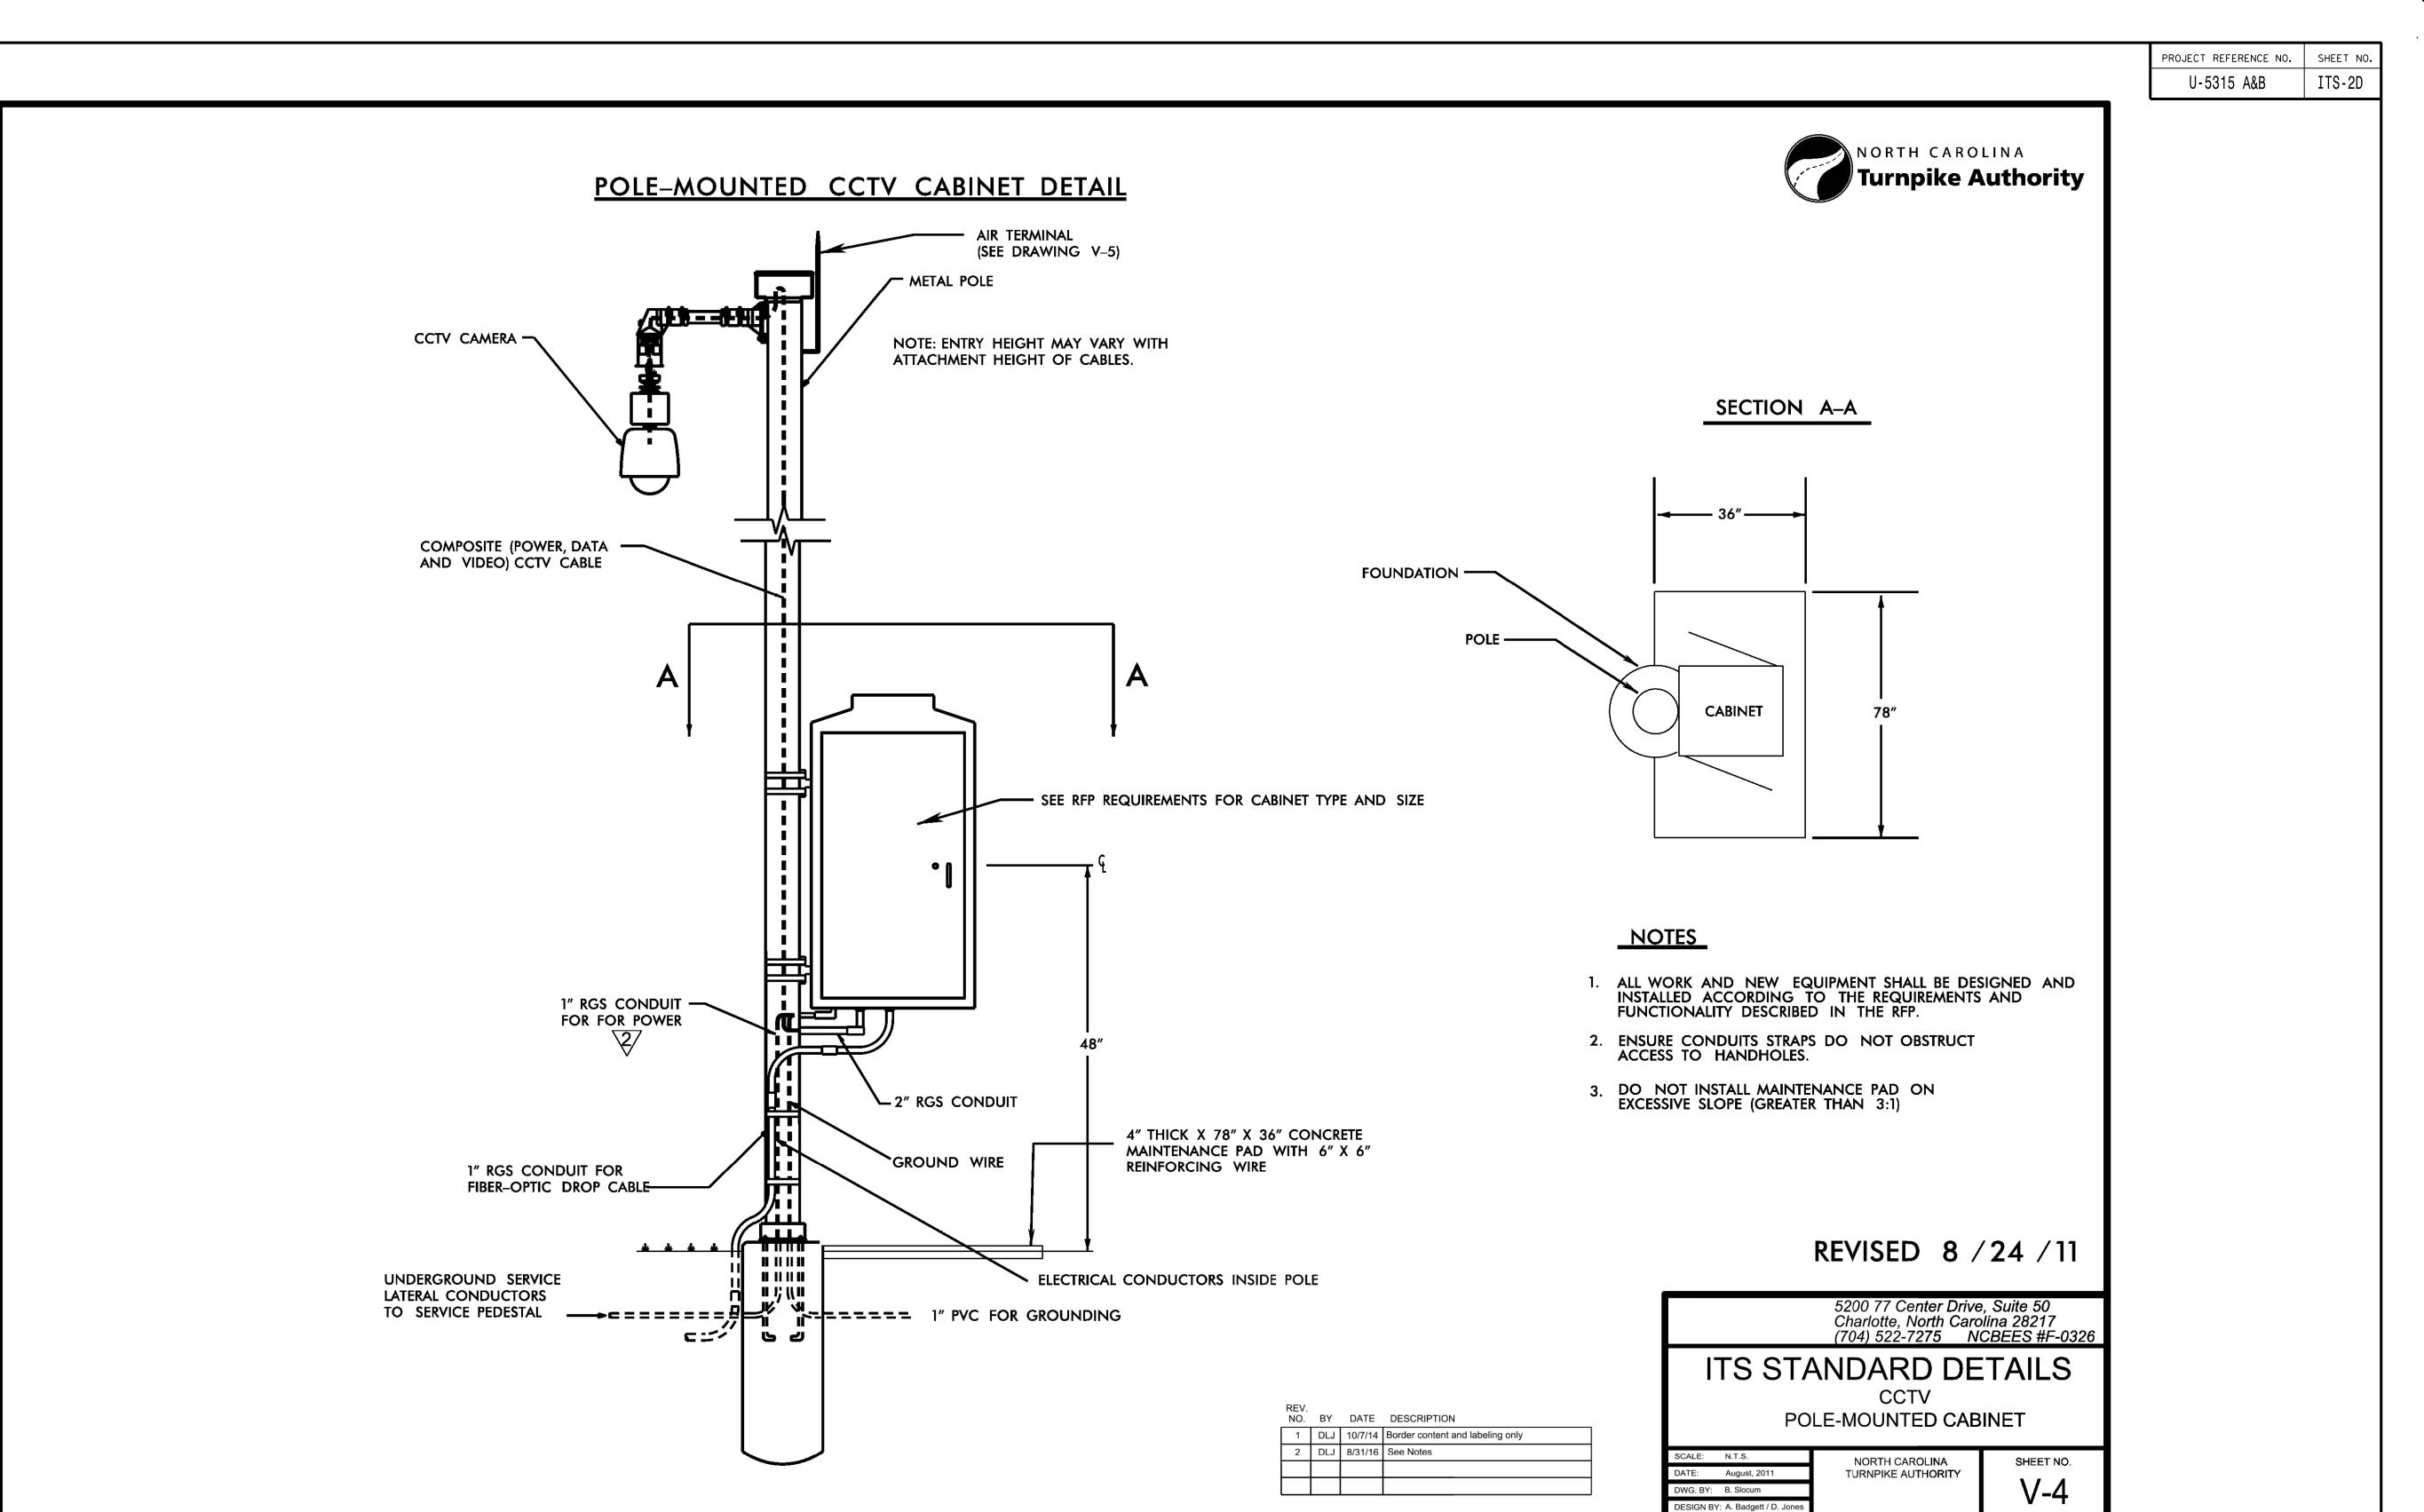


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NORTH CAROLINA TURNPIKE AUTHORITY ITS STANDARD DETAIL

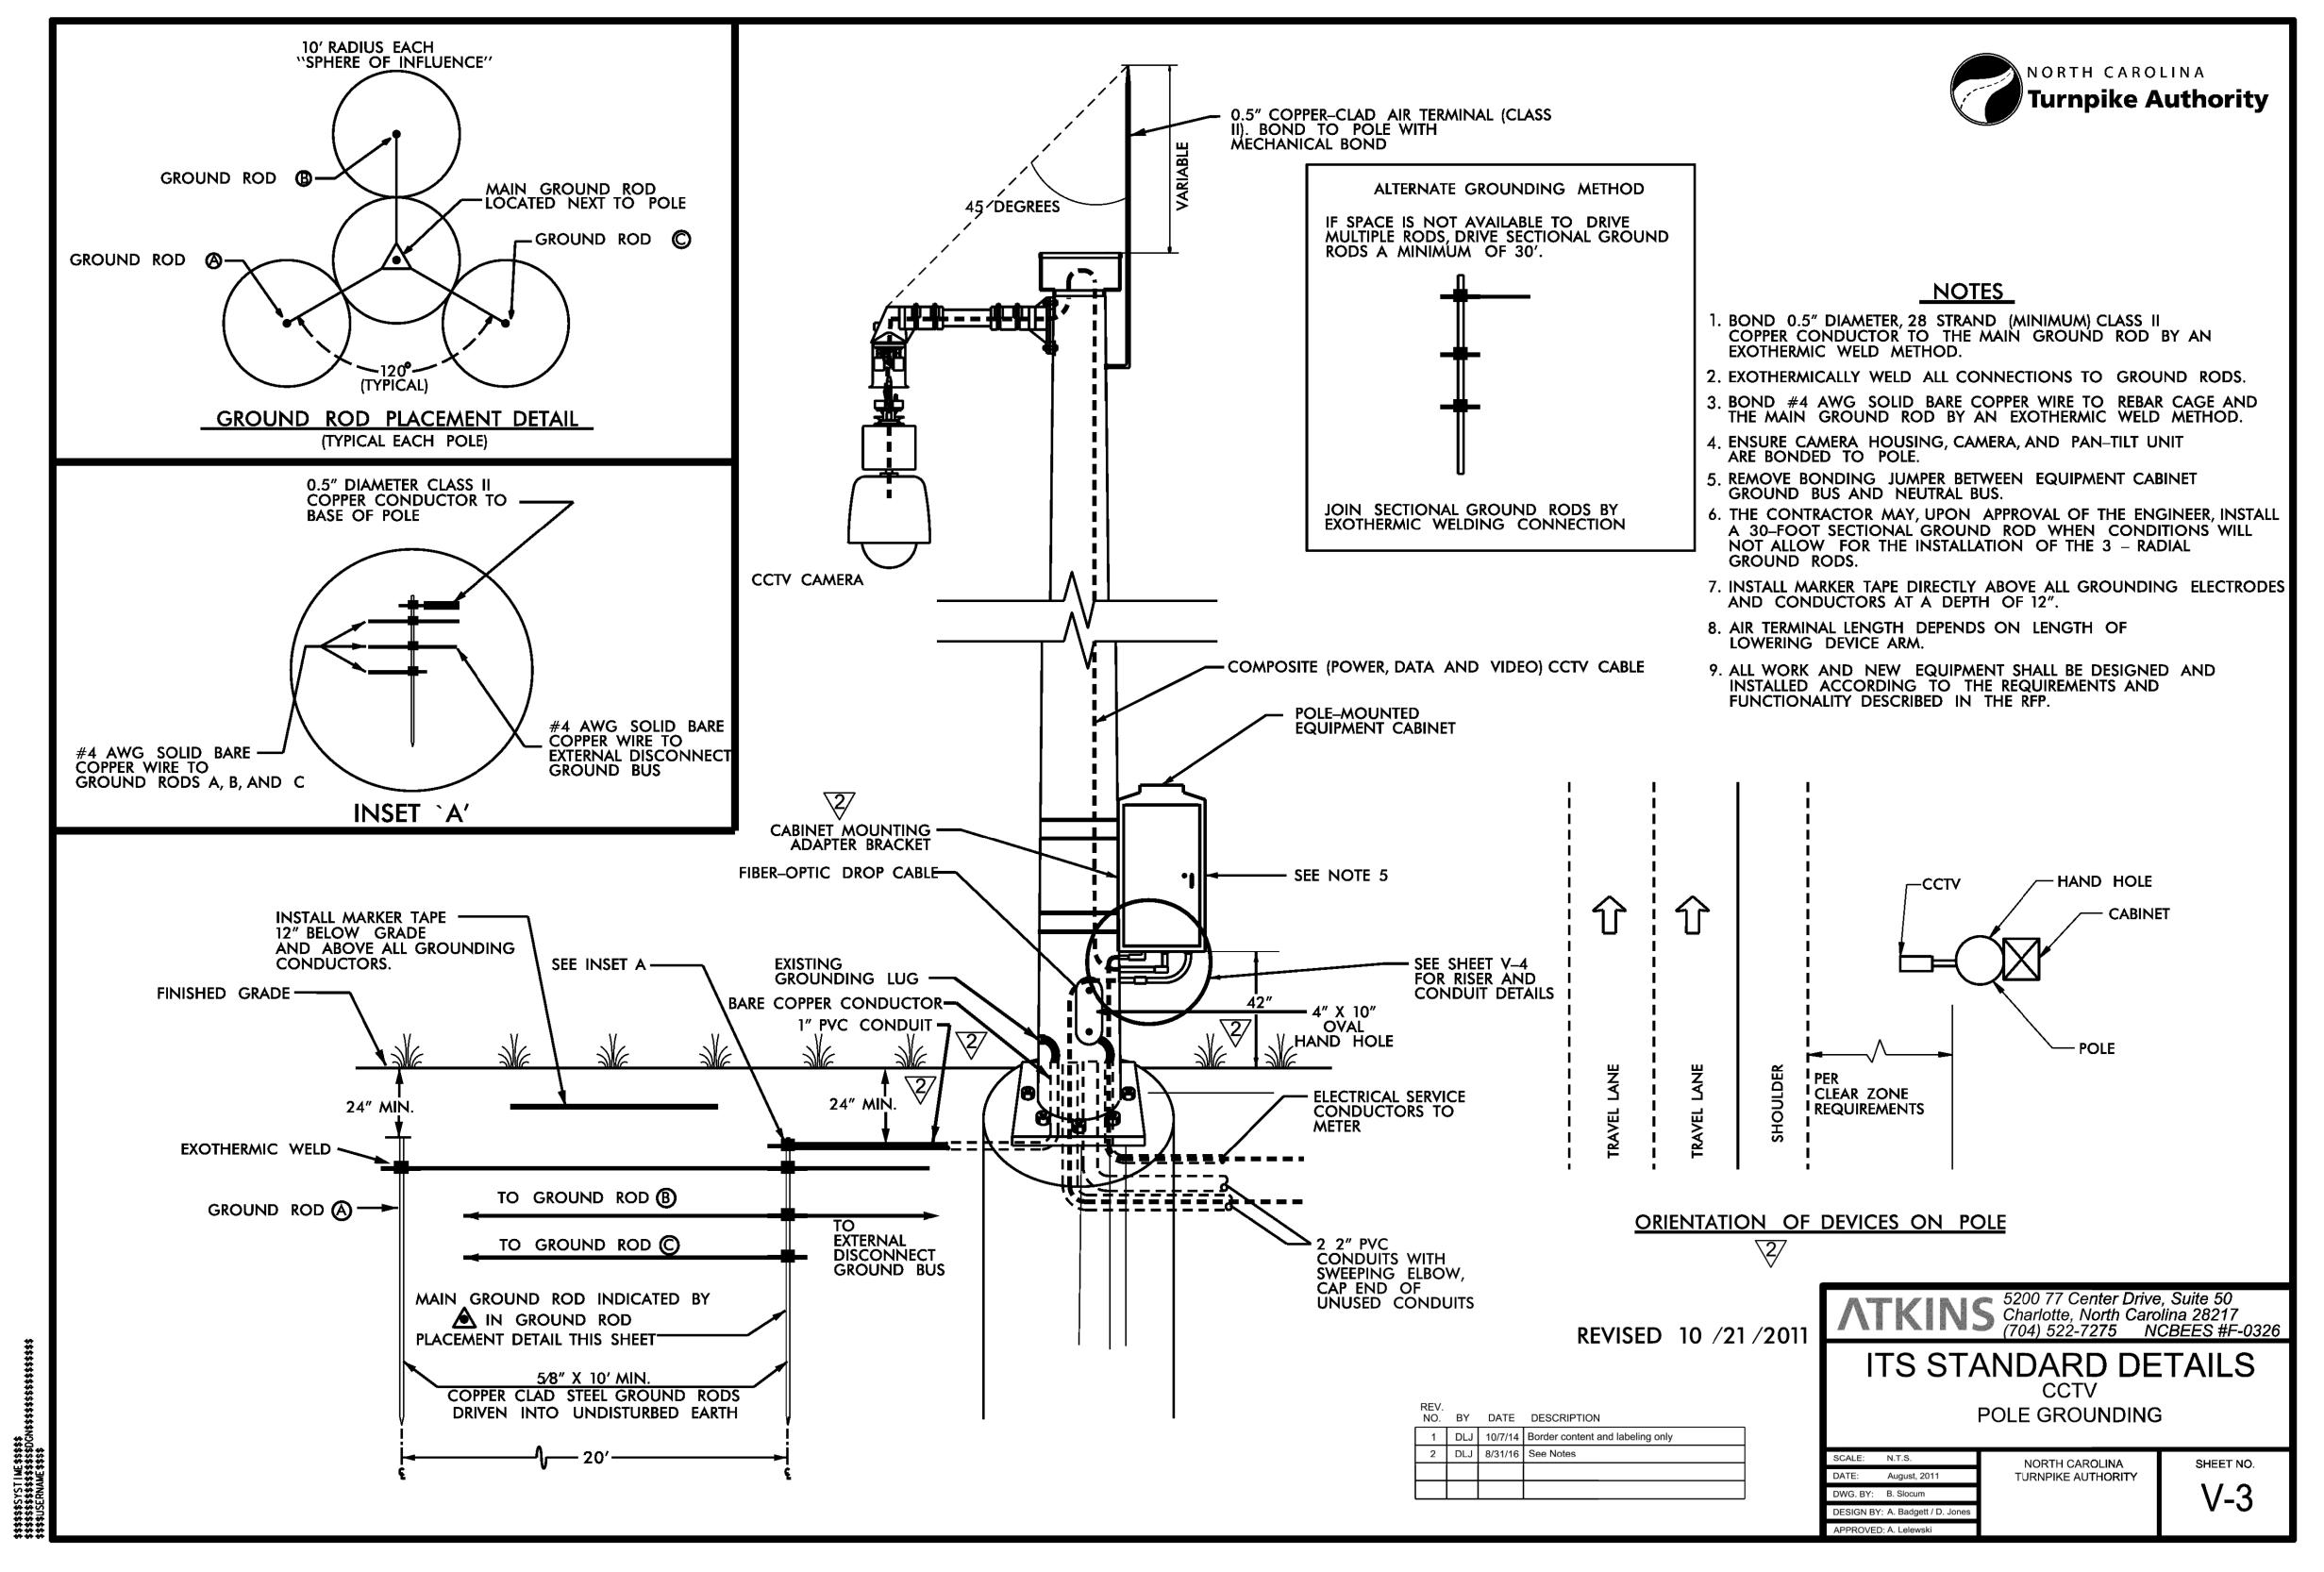
	DIVISION	05 WAKE COU	NTY	TOWN ()F CAR
	PLAN DATE:	NOVEMBER 2017	REVIEWED BY:	C.B. HO	LDEN
29	PREPARED BY:	D.T. SEARS	REVIEWED BY:		
		REVISIONS		INIT.	DATE

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N/A

APPROVED: A. Lelewski

NORTH CAROLINA TURNPIKE AUTHORITY ITS STANDARD DETAIL


DIVISION 05 WAKE COUNTY TOWN OF CARY
PLAN DATE: NOVEMBER 2017 REVIEWED BY: C.B. HOLDEN
PREPARED BY: D.T. SEARS REVIEWED BY:

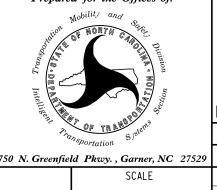REVISIONS INIT. DATE

CADD Filename: U5315_ITS_standarddetails.dg

R: *Traffic*||TS*DGN*U5315_||TS_star



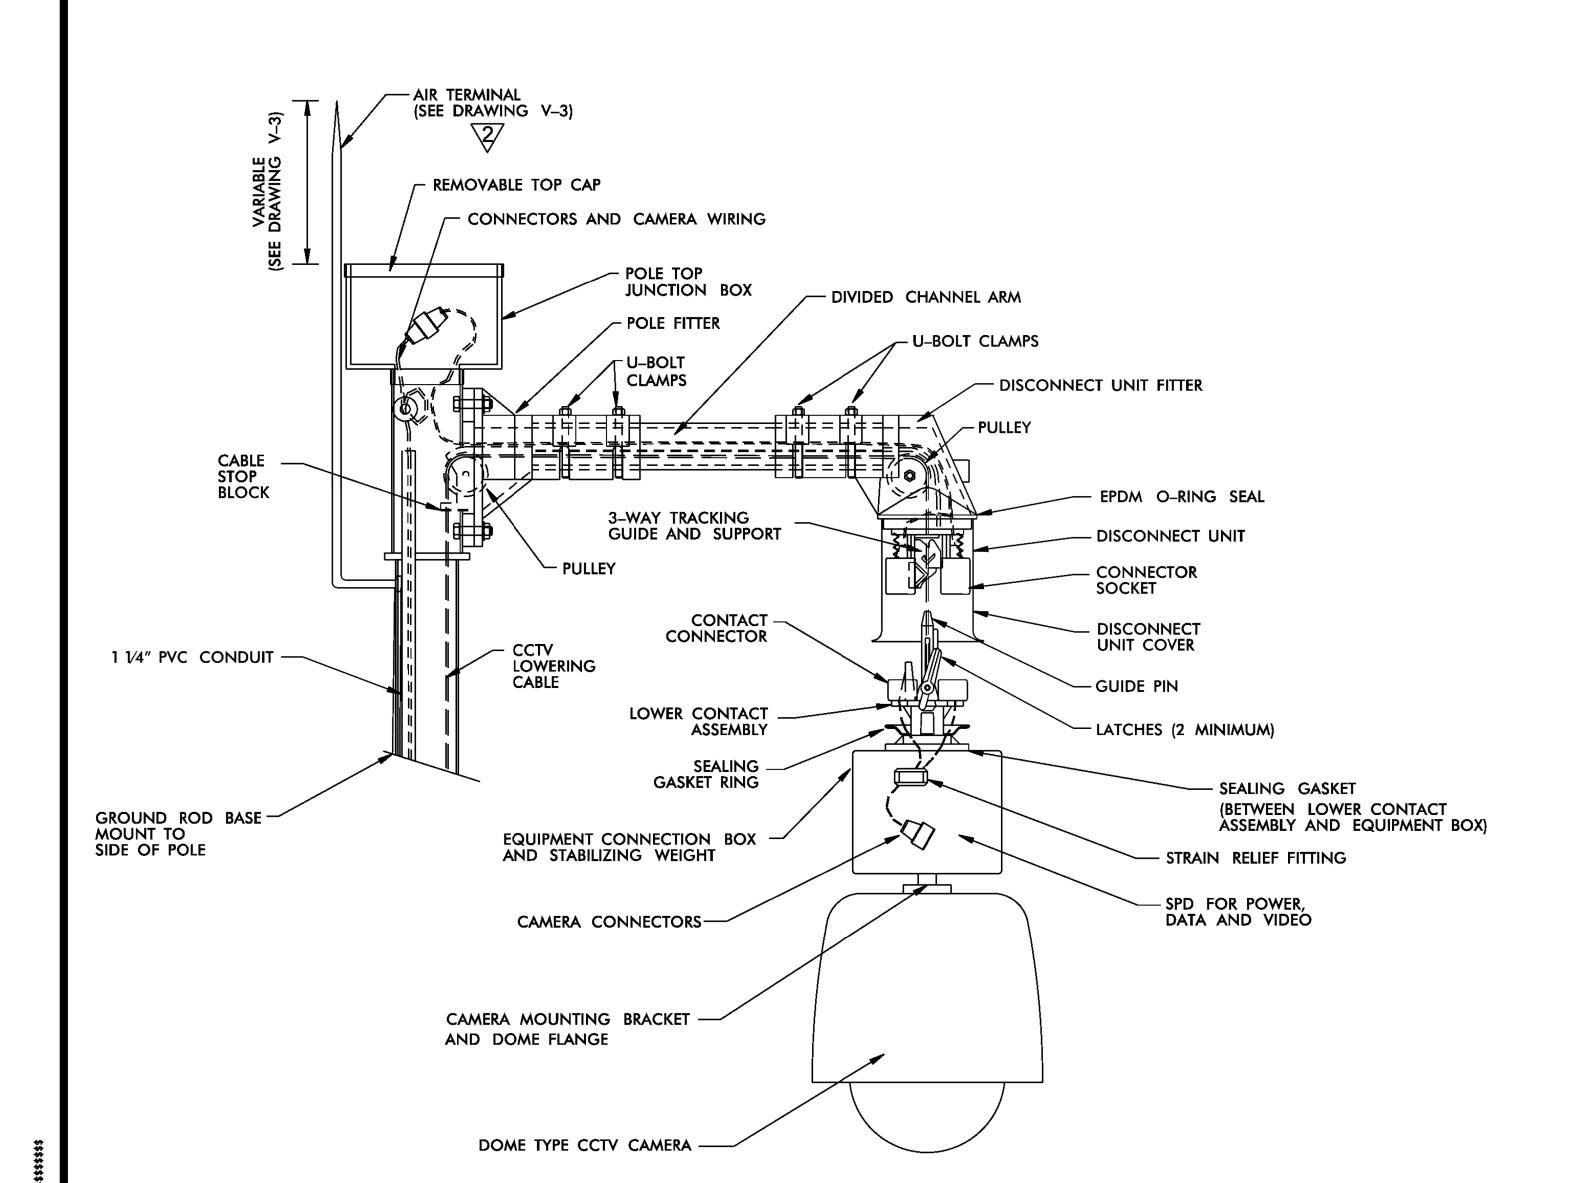

GENERAL NOTES:

- 1. LOWERING DEVICE TO BE SHIPPED READY FOR POLE ATTACHMENT TO INCLUDE 100 FT. OF COMPOSITE POWER AND SIGNAL CABLE PREWIRED TO LOWERING DEVICE AT THE FACTORY.
- 2. THE LOWERING DEVICE MANUFACTURER SHALL SUPPLY BOTH A PORTABLE LOWERING TOOL WITH A MANUAL HAND CRANK AND A PORTABLE ELECTRIC DRILL MOTOR WITH CUSTOM CLUTCH ADAPTER. ONE LOWERING TOOL PER EVERY 10 LOWERING DEVICES IS REQUIRED.
- 3. THE LOWERING DEVICE MANUFACTURER SHALL PROVIDE AN ON-SITE INSTALLATION INSPECTION AND OPERATOR INSTRUCTION AND CERTIFICATION. THIS ENSURES THE PRODUCT IS ASSEMBLED CORRECTLY AND, MORE IMPORTANTLY, THAT ALL NECESSARY PERSONS ARE TRAINED IN THE PROPER, SAFE OPERATION OF THE SYSTEM. BEFORE ERECTING THE FIRST POLE THE CONTRACTOR MUST CONTACT THE LOWERING DEVICE SUPPLIER AND SCHEDULE A FACTORY REPRESENTATIVE TO BE ON-SITE.
- 4. LOWERING DEVICE CONNECTION TO TOP OF POLE SHALL BE CAPABLE OF SERVICE TENSION AND SHEAR OF 1 KIP MINIMUM. THE CONTRACTOR SHALL PROVIDE PRODUCT CUT SHEET AND CAPACITY DATA FOR THE ENGINEER'S REVIEW AND APPROVAL PRIOR TO INSTALLATION.
- 5. CAMERA TO BE MOUNTED TO CAMERA JUNCTION BOX AND STABILIZING WEIGHT VIA 1 1/2" STANDARD NPT PIPE THREAD.
- 6. USE AIR TERMINAL EXTENSION WHEN THE POLE TOP JUNCTION BOX IS WIDER THAN TOP OF POLE.
- 7. ALL WORK AND NEW EQUIPMENT SHALL BE DESIGNED AND INSTALLED ACCORDING TO THE REQUIREMENTS AND FUNCTIONALITY DESCRIBED IN THE RFP.

REVISED 10 /21 /2011

FKINS 5200 77 Center Drive, Suite 50 Charlotte, North Carolina 28217 (704) 522-7275 NCBEES #F-0326

ITS STANDARD DETAILS CCTV CAMERA LOWERING DEVICE

DATE: August, 2011 DWG. BY: B. Slocum DESIGN BY: A. Badgett / D. Jones

APPROVED: A. Lelewski

NORTH CAROLINA TURNPIKE AUTHORITY

SHEET NO. V-5

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1 DLJ 10/7/14 Border content and labeling only
2 DLJ 8/31/16 See Notes

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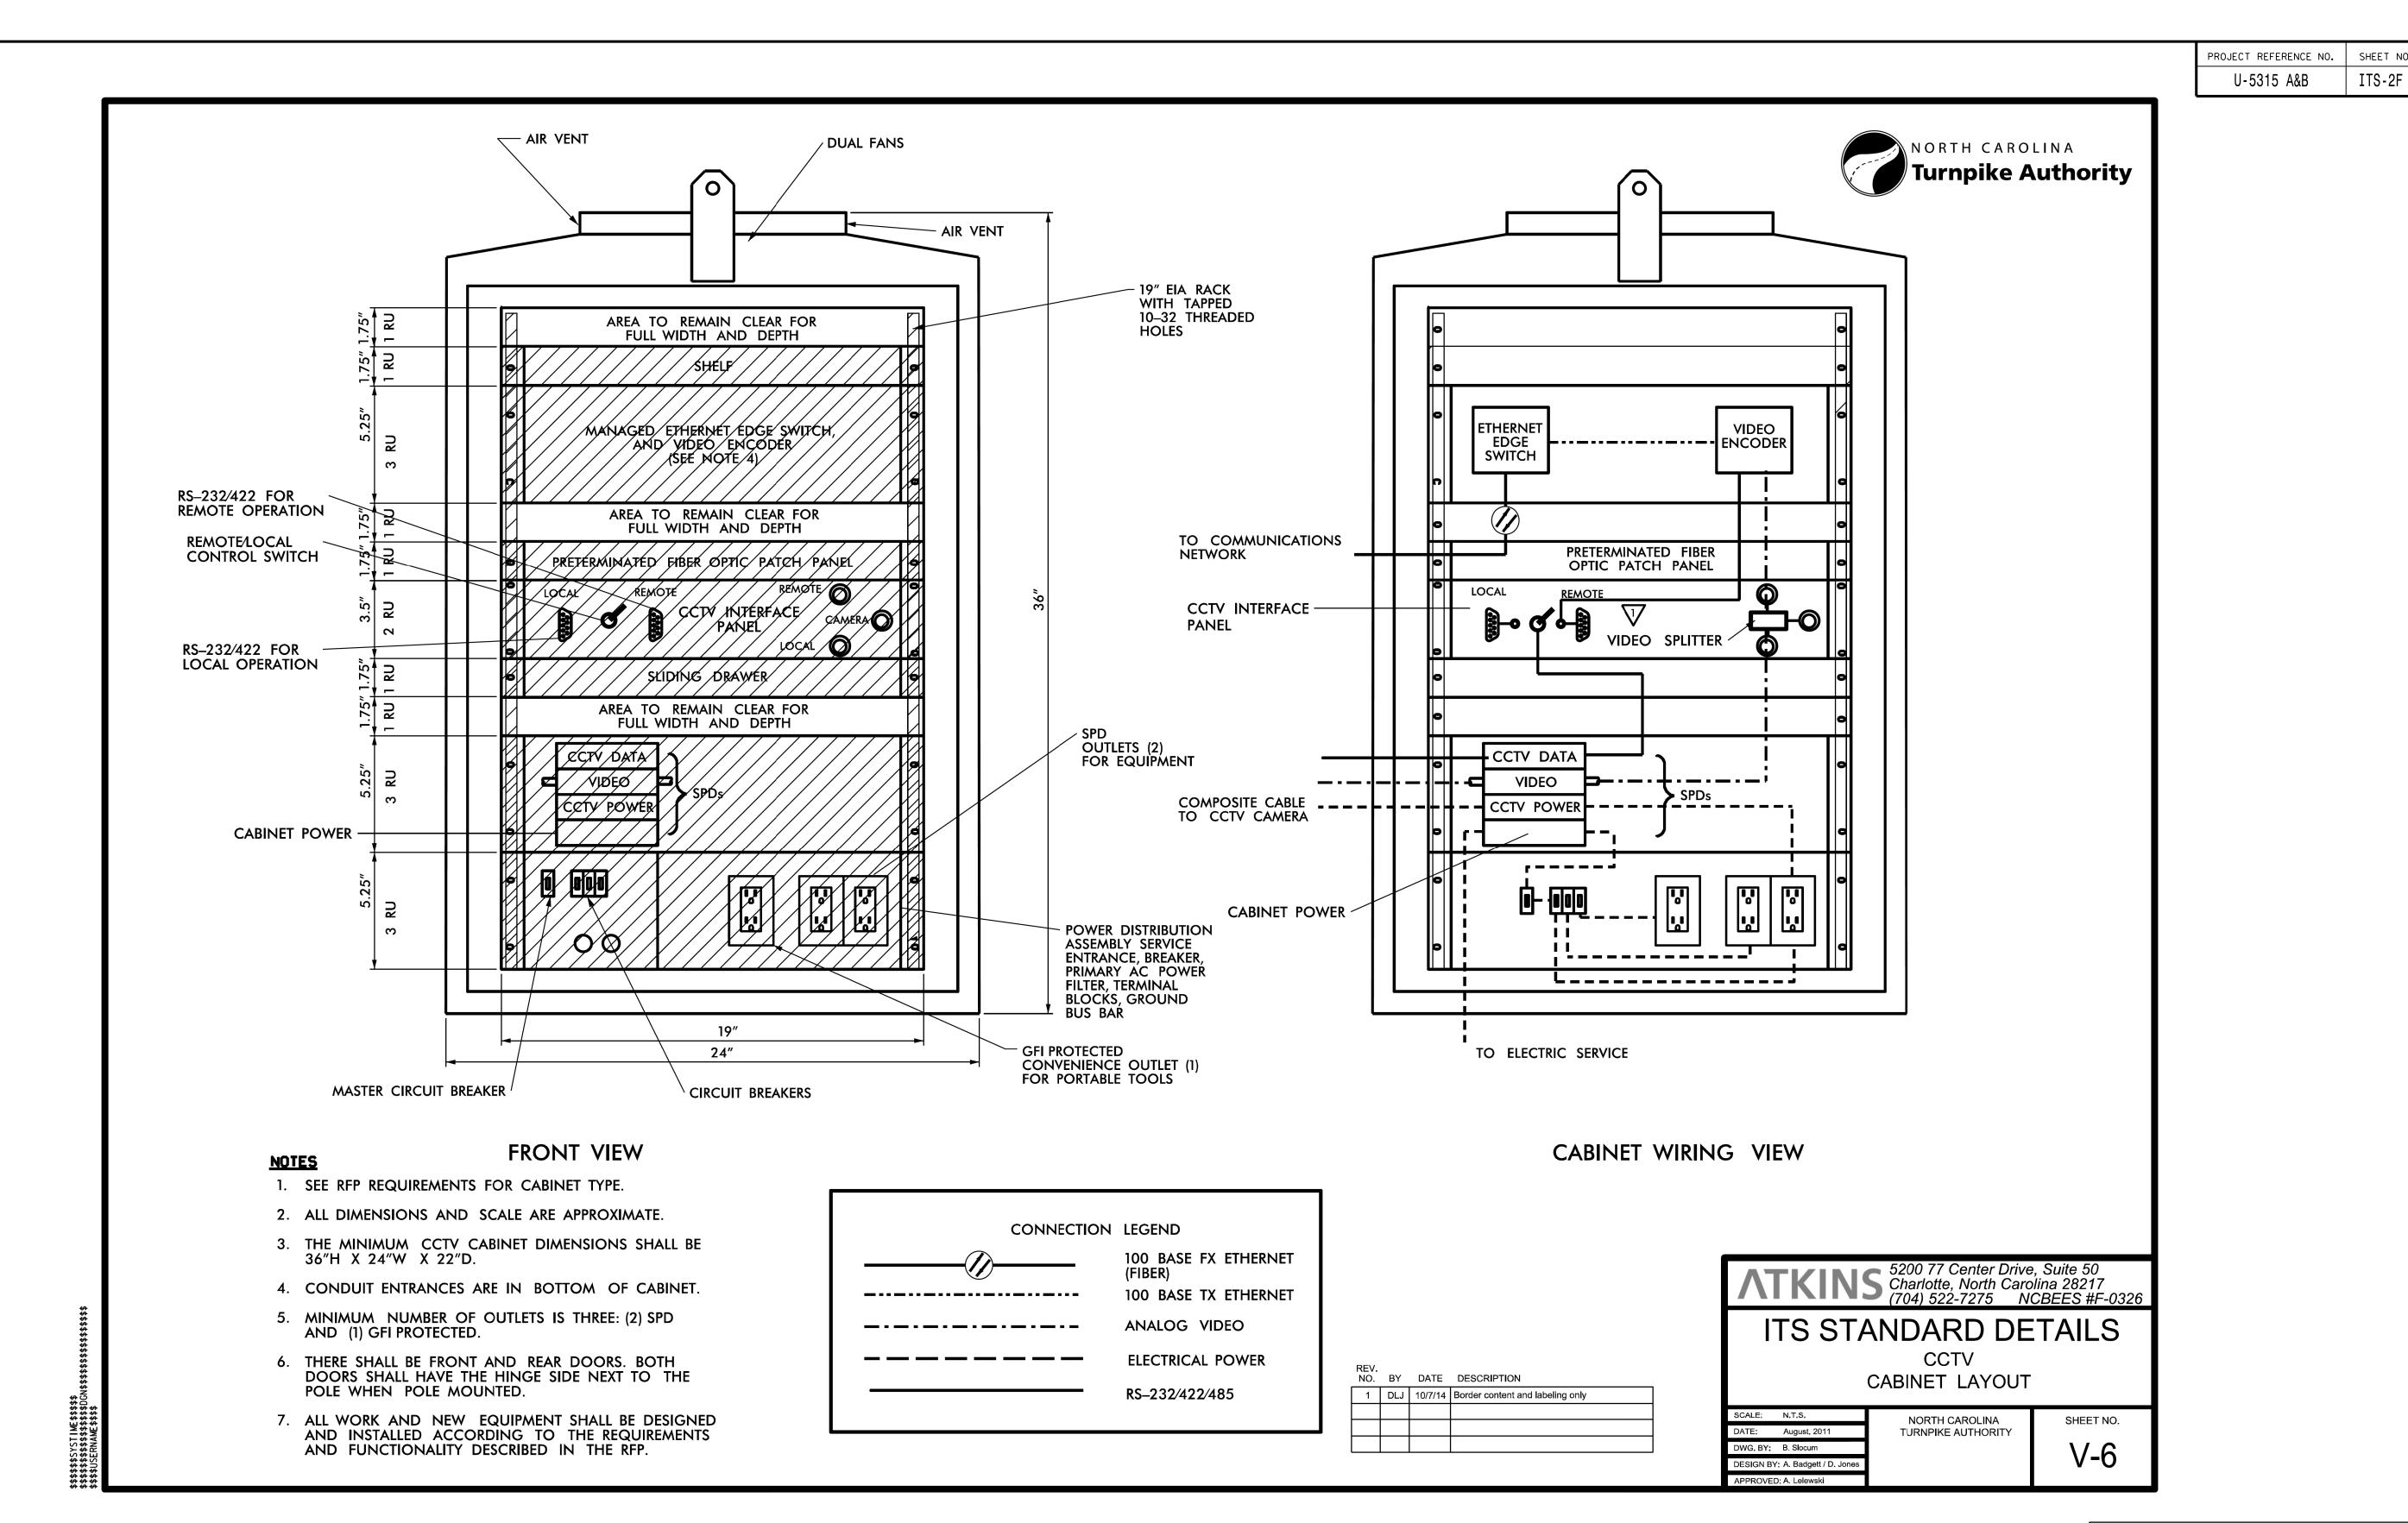
NORTH CAROLINA TURNPIKE AUTHORITY ITS STANDARD DETAIL

DIVISION 05 WAKE COUNTY TOWN OF CARY PLAN DATE: NOVEMBER 2017 REVIEWED BY: C.B. HOLDEN PREPARED BY: D.T. SEARS REVIEWED BY: REVISIONS INIT. DATE

CADD Filenome: U5315_ITS_standarddetails.dg

900 RIDGEFIELD DRIVE SUITE 350

RALEIGH, NORTH CAROLINA 27609-3960 NC LICENSE NO. F-0112 • (919) 878-9560



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NC LICENSE NO. F-0112 • (919) 878-9560

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NORTH CAROLINA TURNPIKE AUTHORITY ITS STANDARD DETAIL

DIVISION 05 WAKE COUNTY TOWN OF CARY PLAN DATE: NOVEMBER 2017 REVIEWED BY: C.B. HOLDEN PREPARED BY: D.T. SEARS REVIEWED BY: REVISIONS INIT. DATE

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PROJECT REFERENCE NO. U-5315 A&B SHEET INTENTIONALLY LEFT BLANK DOCUMENT NOT CONSIDERED FINAL UNLESS ALL SIGNATURES COMPLETED NORTH CAROLINA TURNPIKE AUTHORITY ITS STANDARD DETAIL PLANS PREPARED BY: DIVISION 05 WAKE COUNTY TOWN OF CARY PLAN DATE: NOVEMBER 2017 REVIEWED BY: C.B. HOLDEN 750 N. Greenfield Pkwy., Garner, NC 27529 PREPARED BY: D.T. SEARS REVIEWED BY: RUMMEL, KLEPPER & KAHL, LLP REVISIONS INIT. DATE 900 RIDGEFIELD DRIVE SUITE 350 RALEIGH, NORTH CAROLINA 27609-3960

NC LICENSE NO. F-0112 • (919) 878-9560

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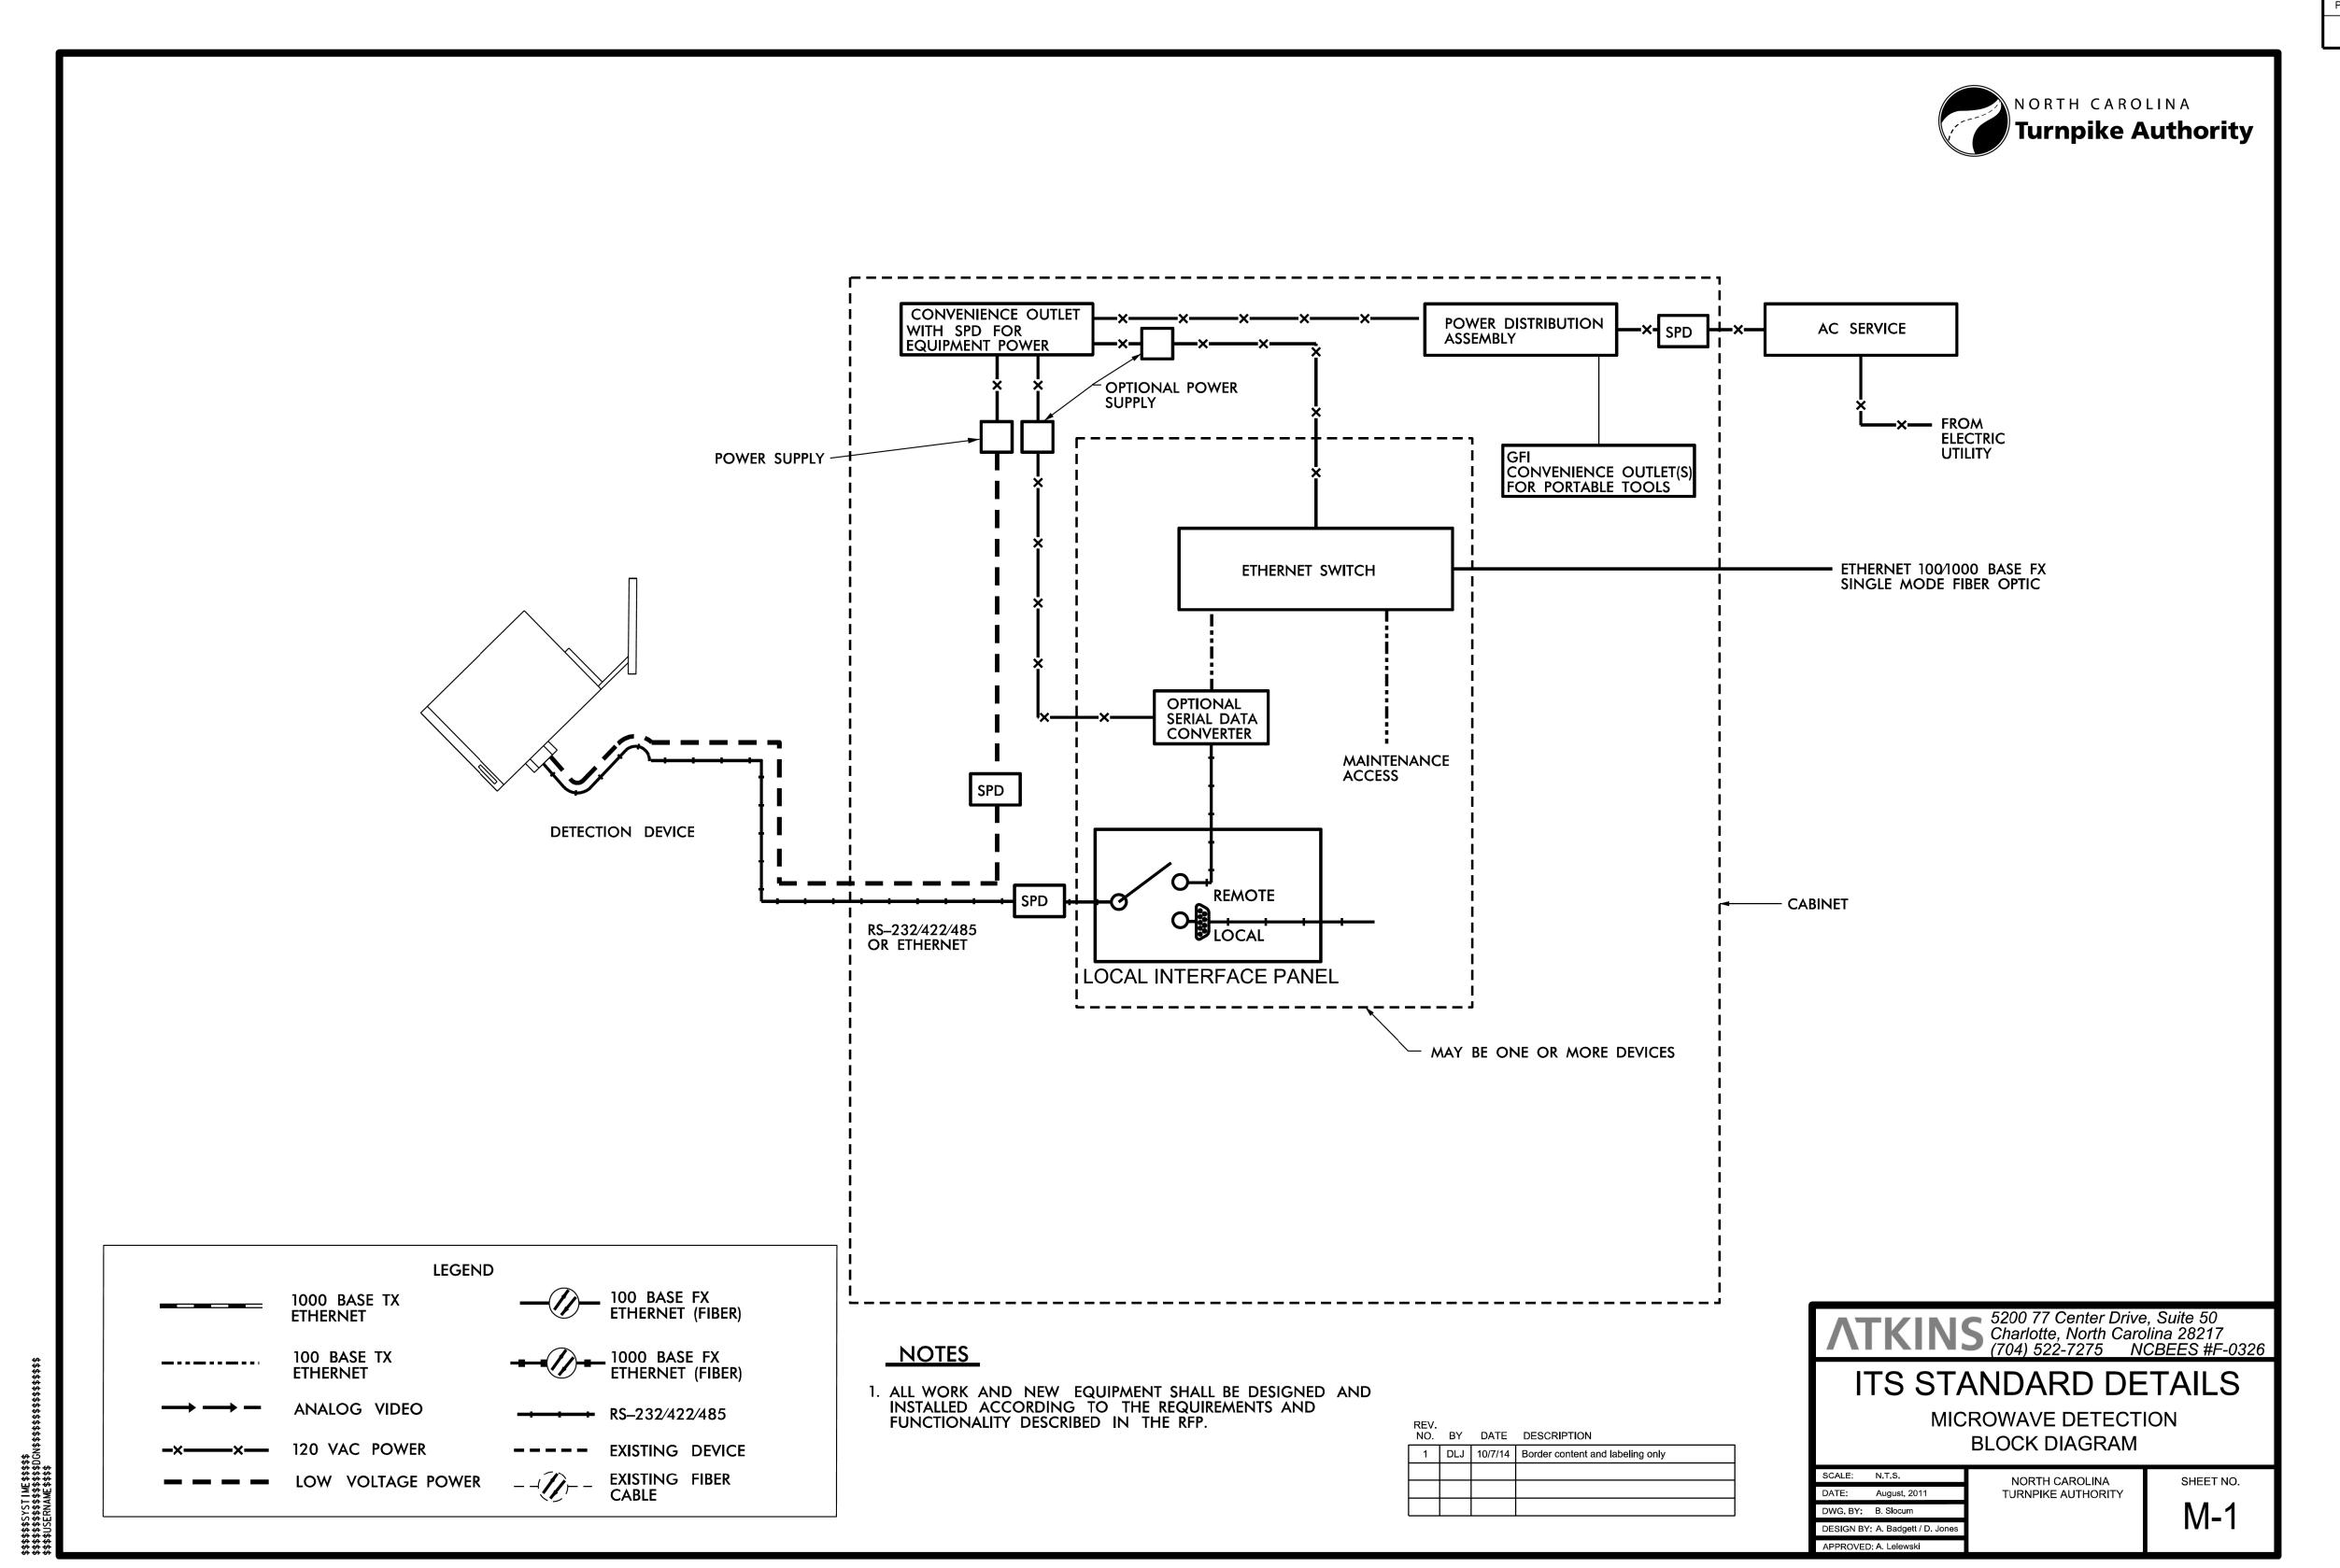
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NORTH CAROLINA TURNPIKE AUTHORITY ITS STANDARD DETAIL


DIVISION 05 WAKE COUNTY TOWN OF CARY PLAN DATE: NOVEMBER 2017 REVIEWED BY: C.B. HOLDEN PREPARED BY: D.T. SEARS REVIEWED BY: REVISIONS INIT. DATE

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PROJECT REFERENCE NO. SHEET NO. ITS-2K U-5315 A&B

NORTH CAROLINA

Turnpike Authority

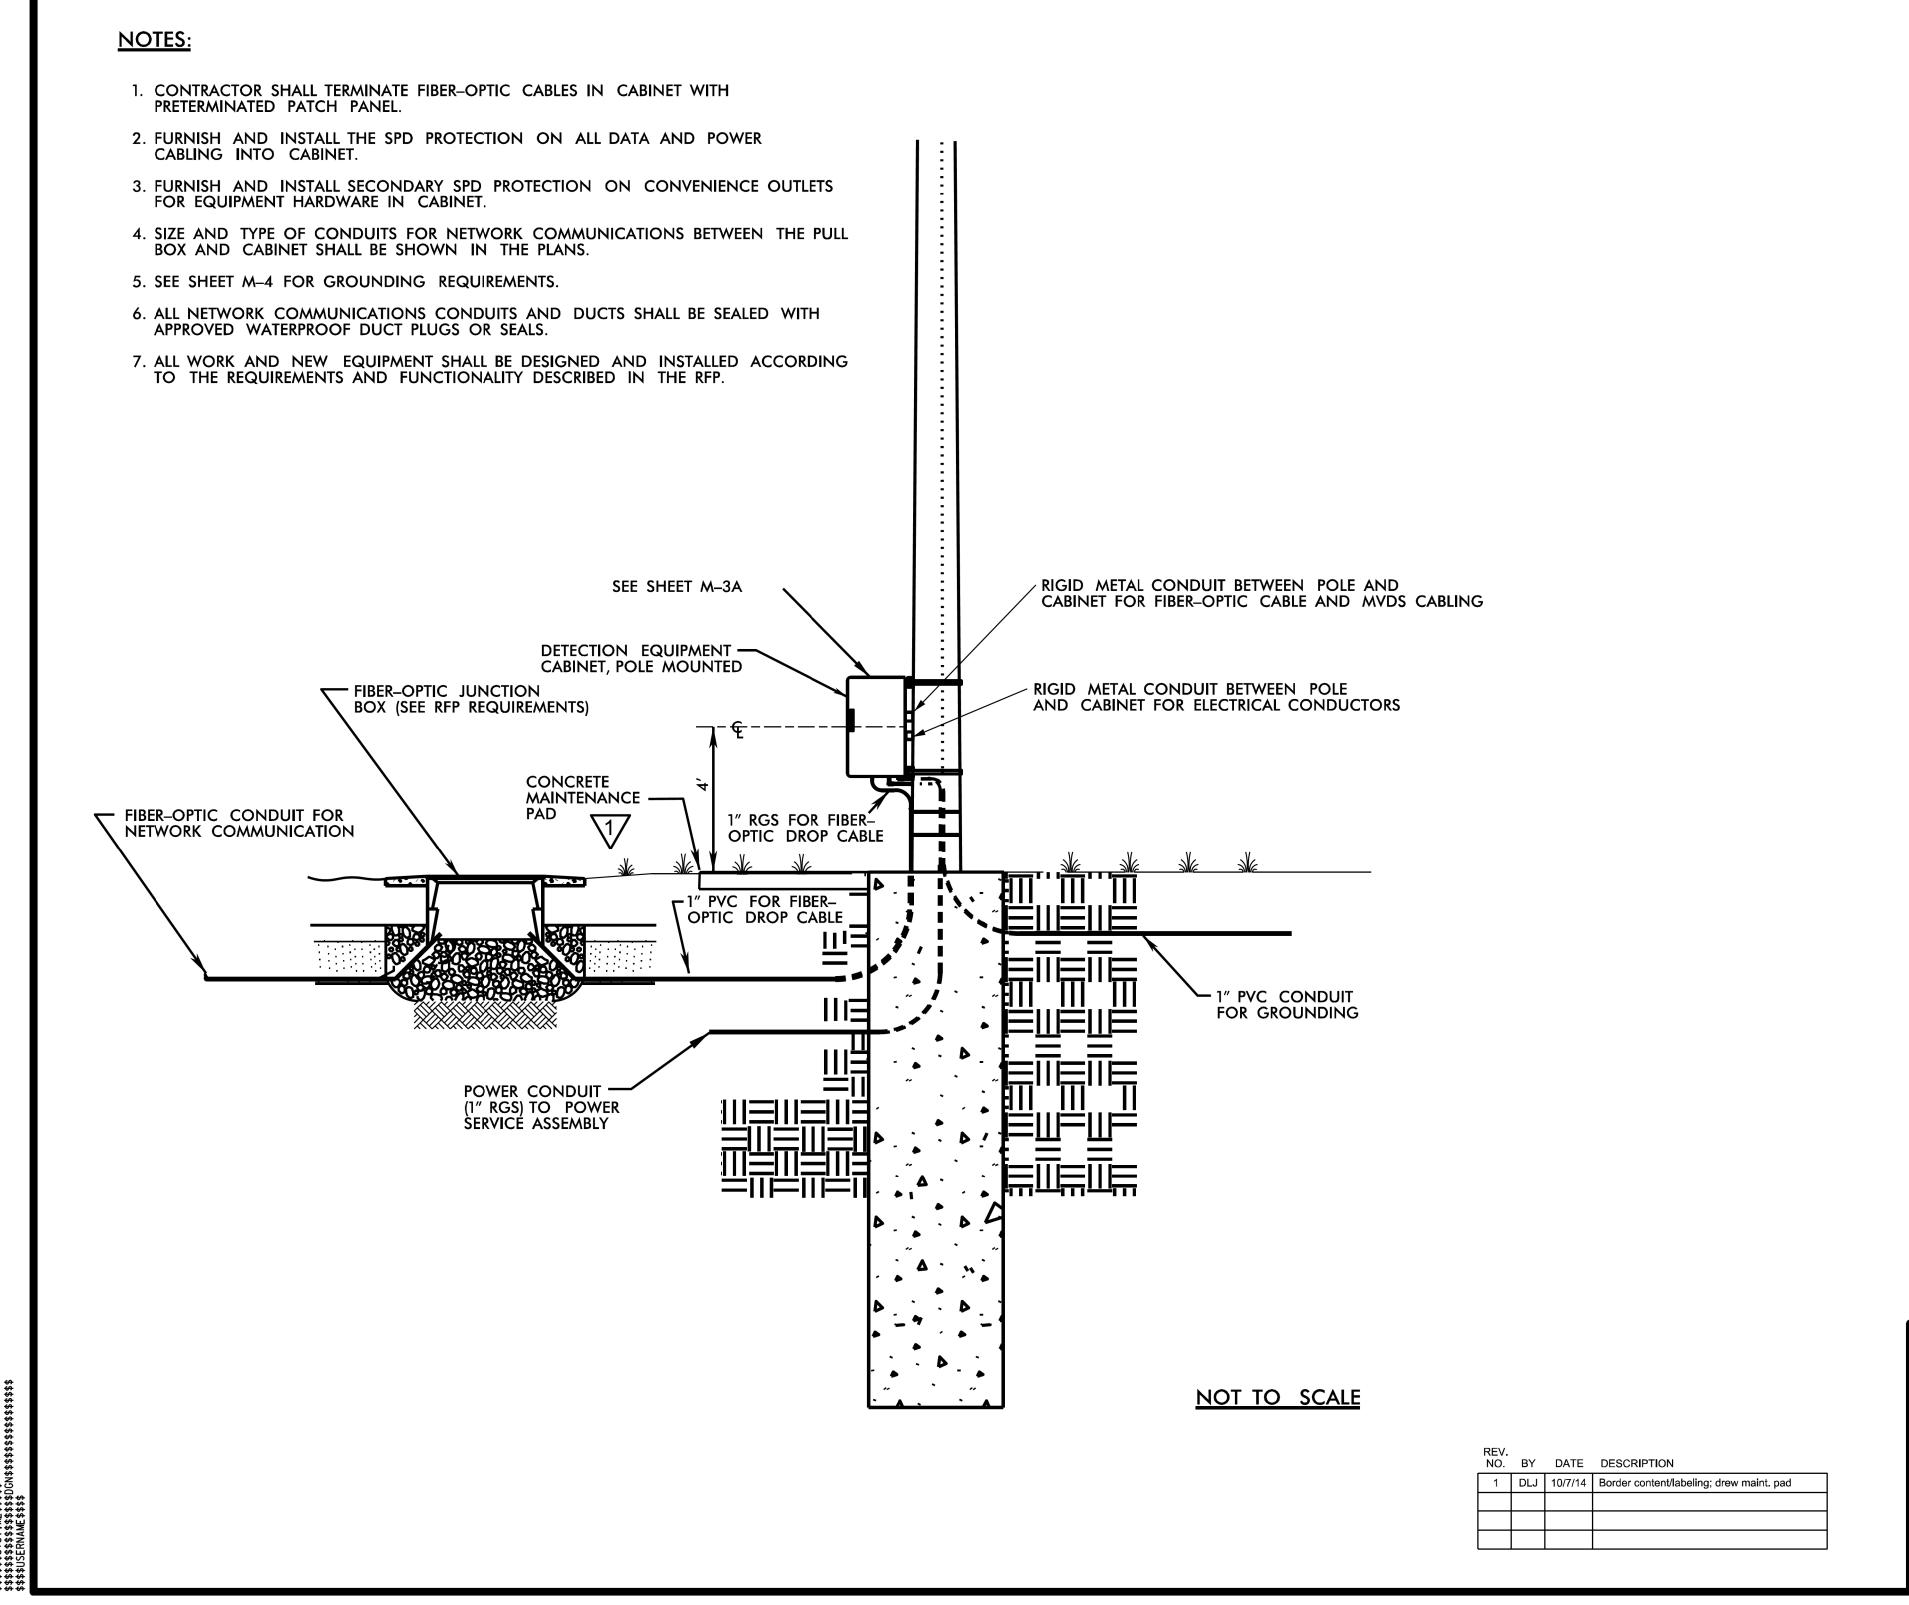

FKINS 5200 77 Center Drive, Suite 50 Charlotte, North Carolina 28217 (704) 522-7275 NCBEES #F-0326 ITS STANDARD DETAILS

> MICROWAVE DETECTION **ELEVATION VIEW**

SCALE: N.T.S. DATE: August, 2011 DWG. BY: B. Slocum DESIGN BY: A. Badgett / D. Jones

APPROVED; A. Lelewski

NORTH CAROLINA TURNPIKE AUTHORITY

SHEET NO. M-2

> **DOCUMENT NOT CONSIDERED FINAL UNLESS ALL SIGNATURES COMPLETED**



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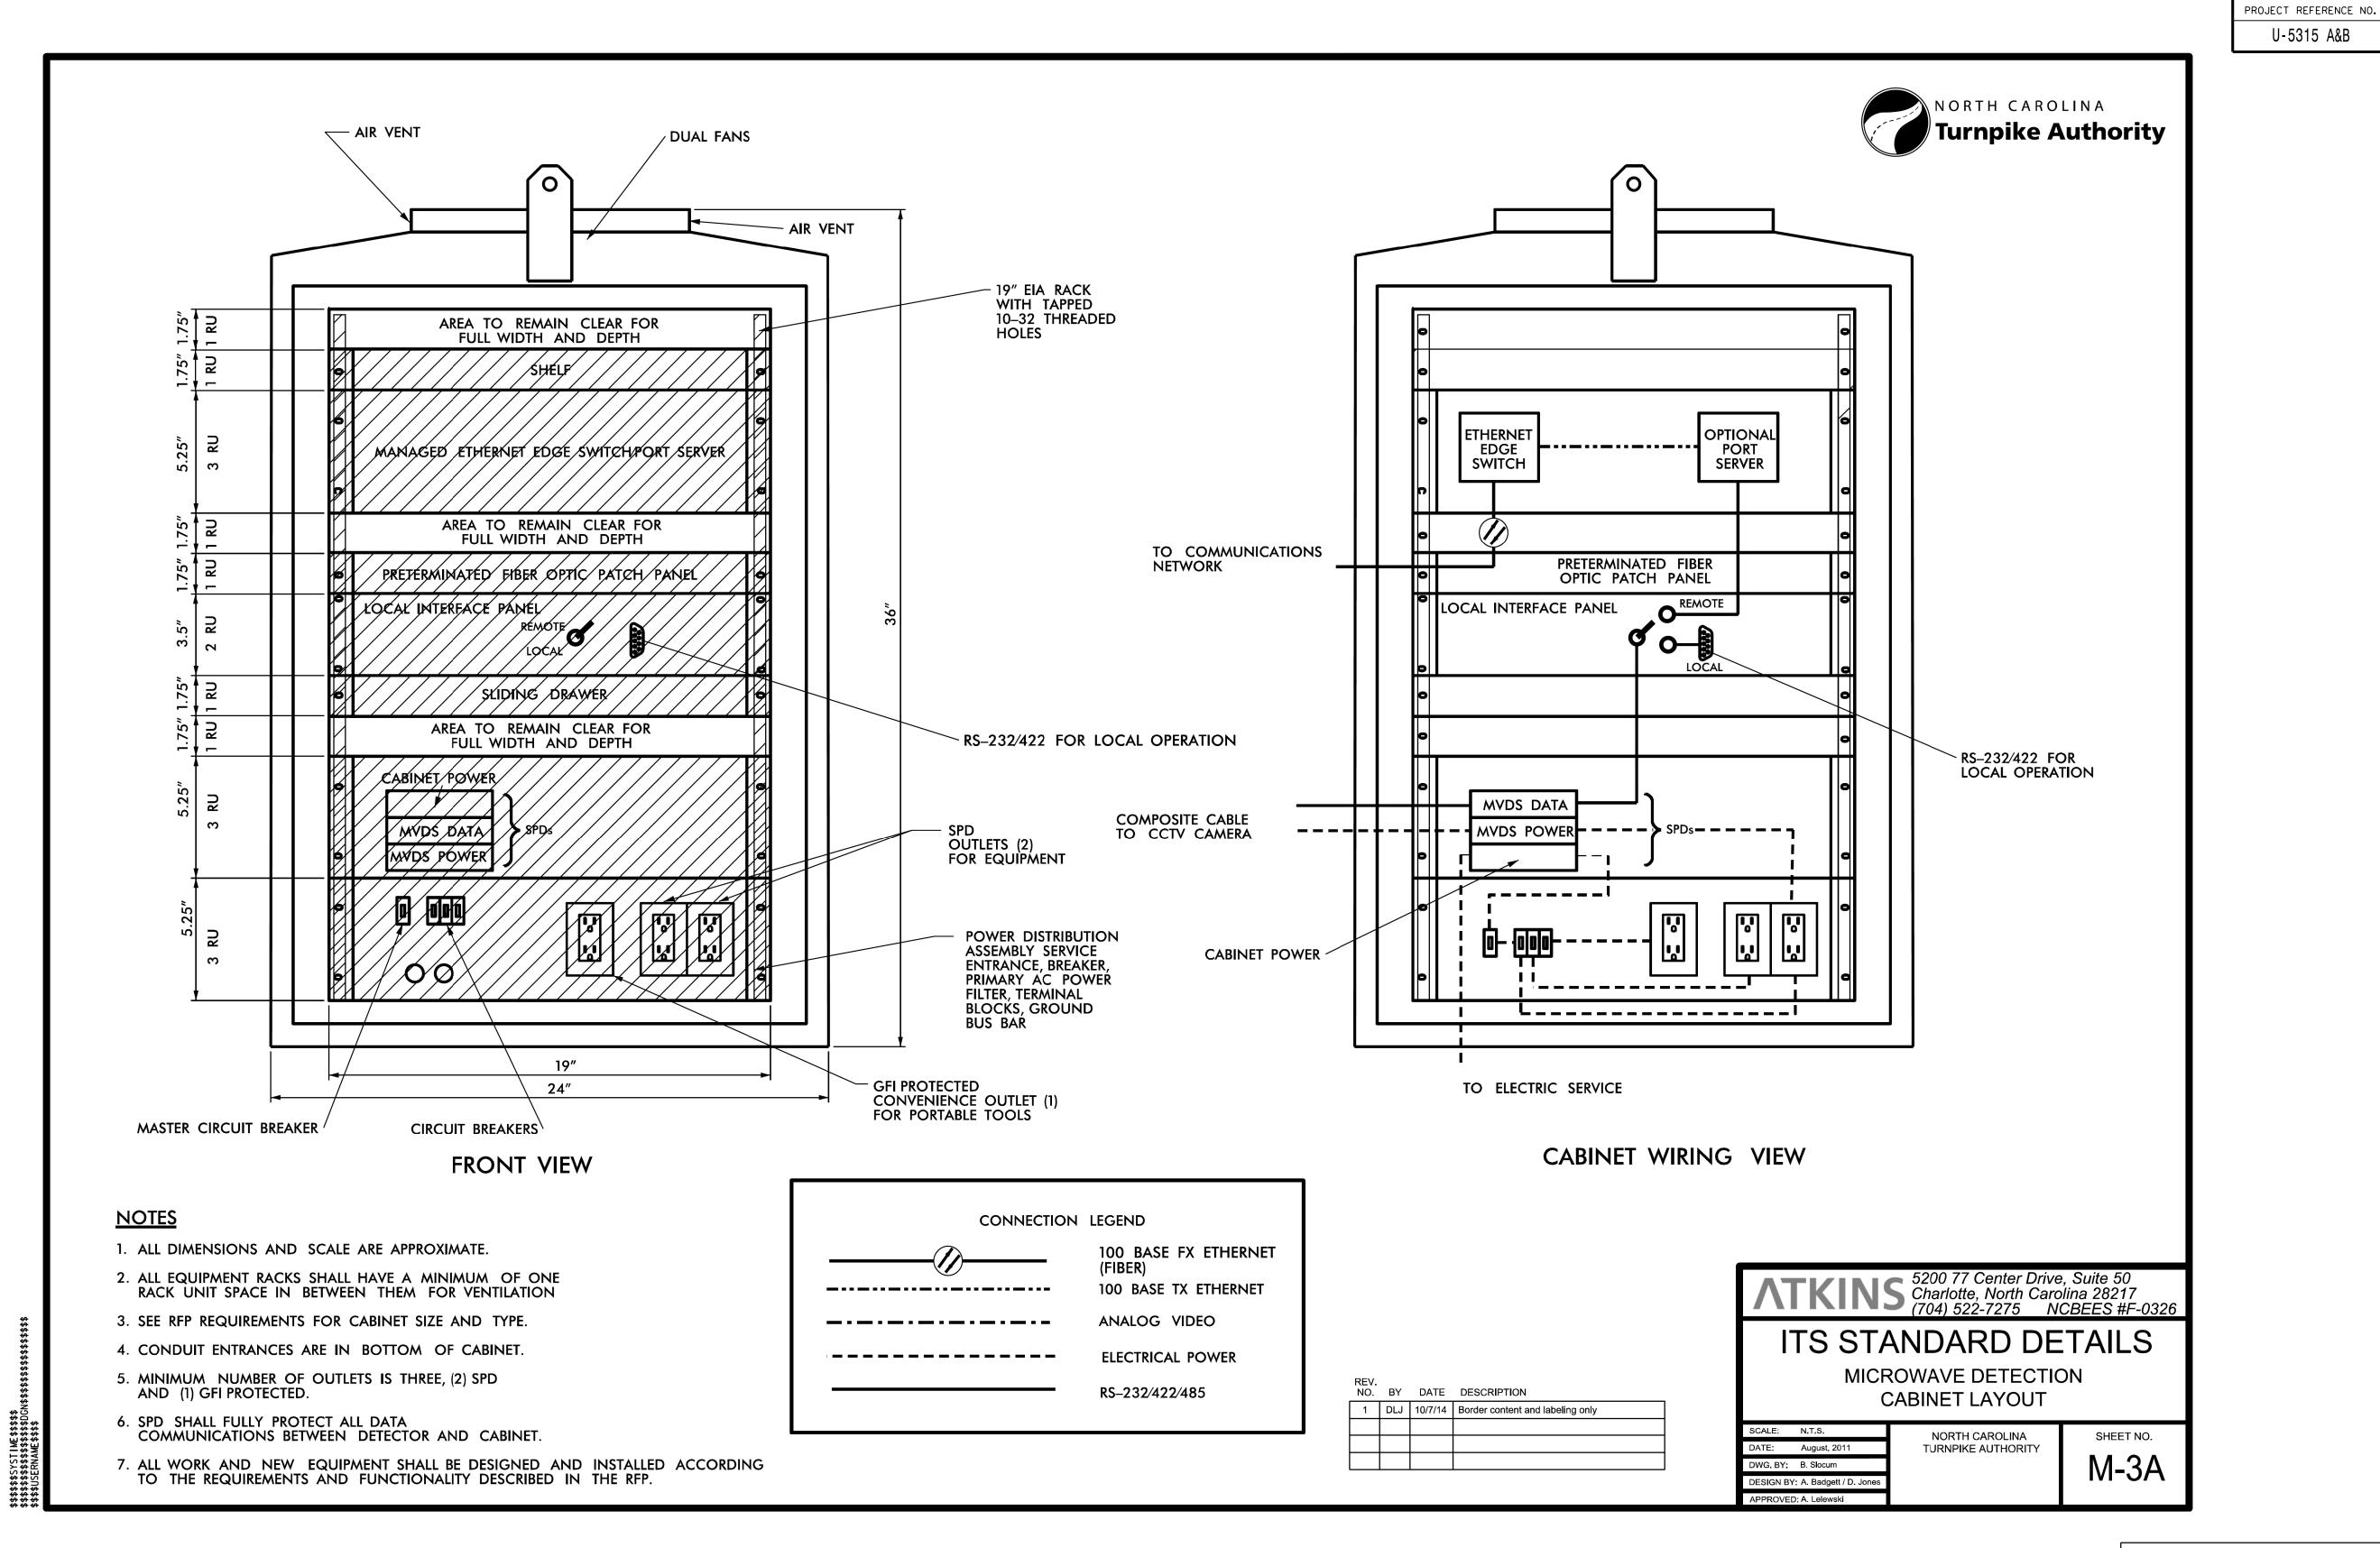


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NORTH CAROLINA TURNPIKE AUTHORITY ITS STANDARD DETAIL

DIVISION 05 WAKE COUNTY TOWN OF CARY PLAN DATE: NOVEMBER 2017 REVIEWED BY: C.B. HOLDEN PREPARED BY: D.T. SEARS REVIEWED BY: REVISIONS INIT. DATE

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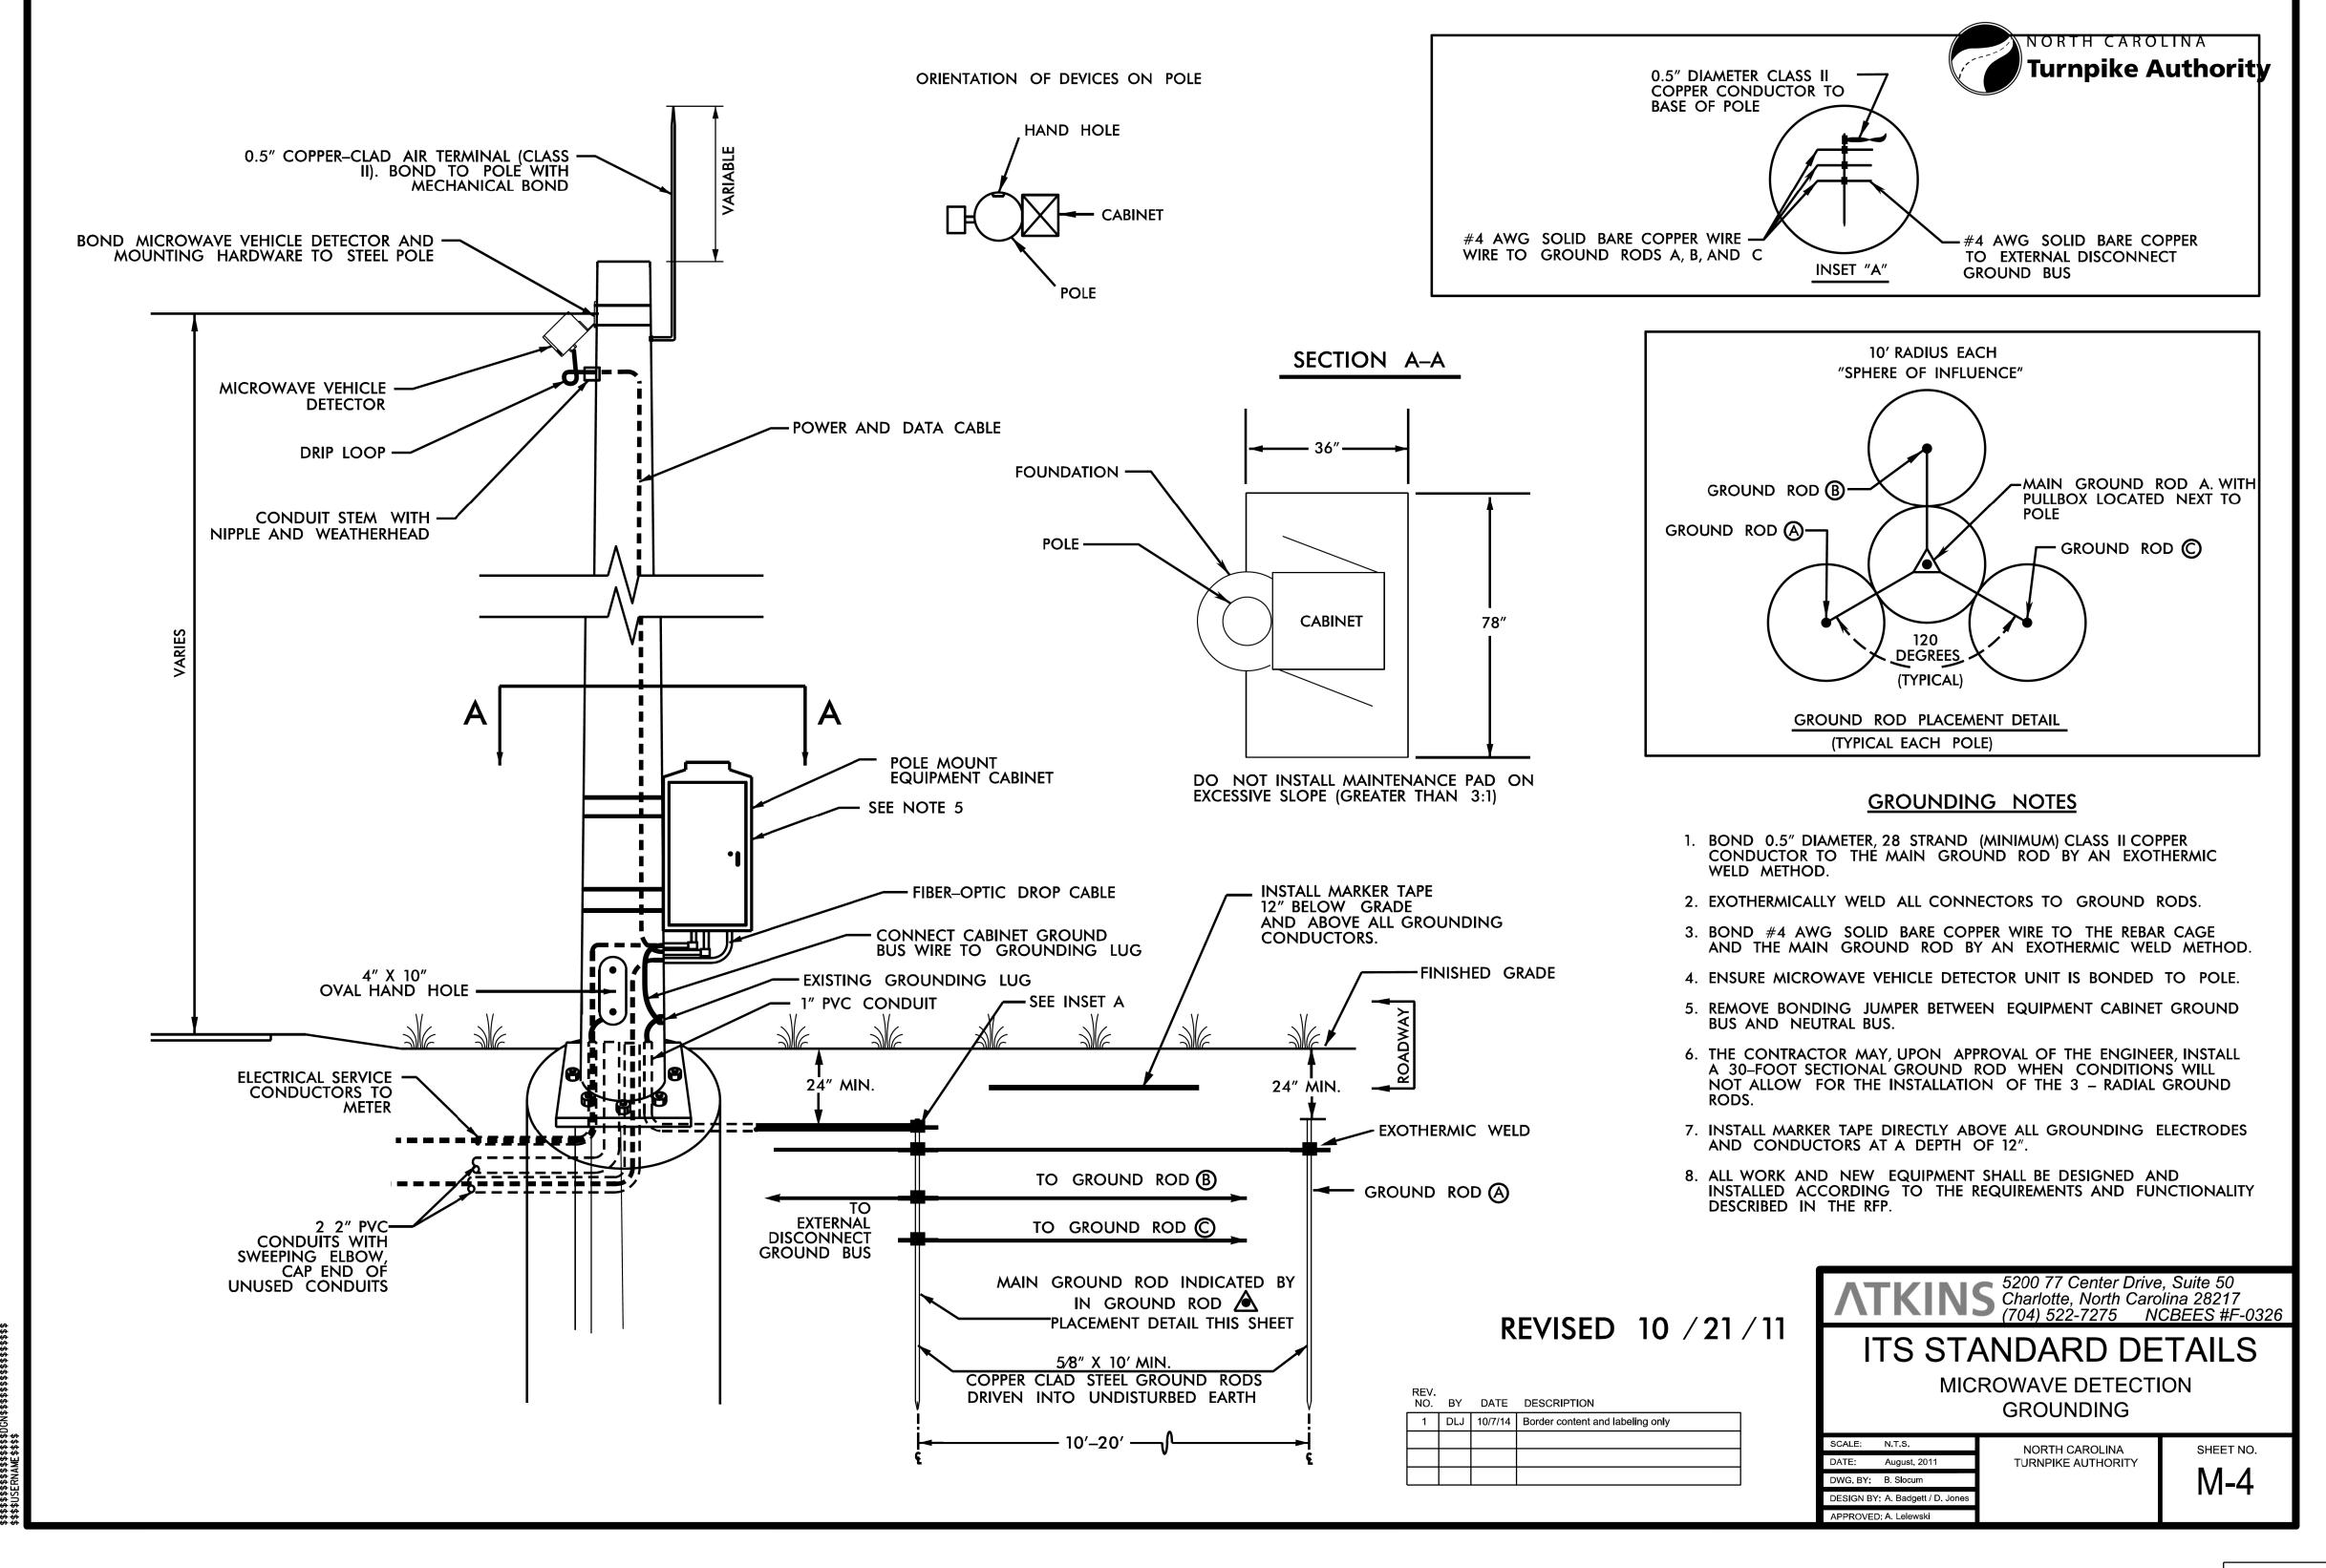
NORTH CAROLINA TURNPIKE AUTHORITY ITS STANDARD DETAIL

	DIVISION	05 WAKE COU	NTY	TOWN ()F CAR
	PLAN DATE:	NOVEMBER 2017	REVIEWED BY: (C.B. HO	LDEN
27529	PREPARED BY:	D.T. SEARS	REVIEWED BY:		
		REVISIONS		INIT.	DATE

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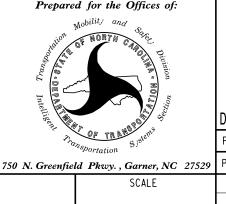
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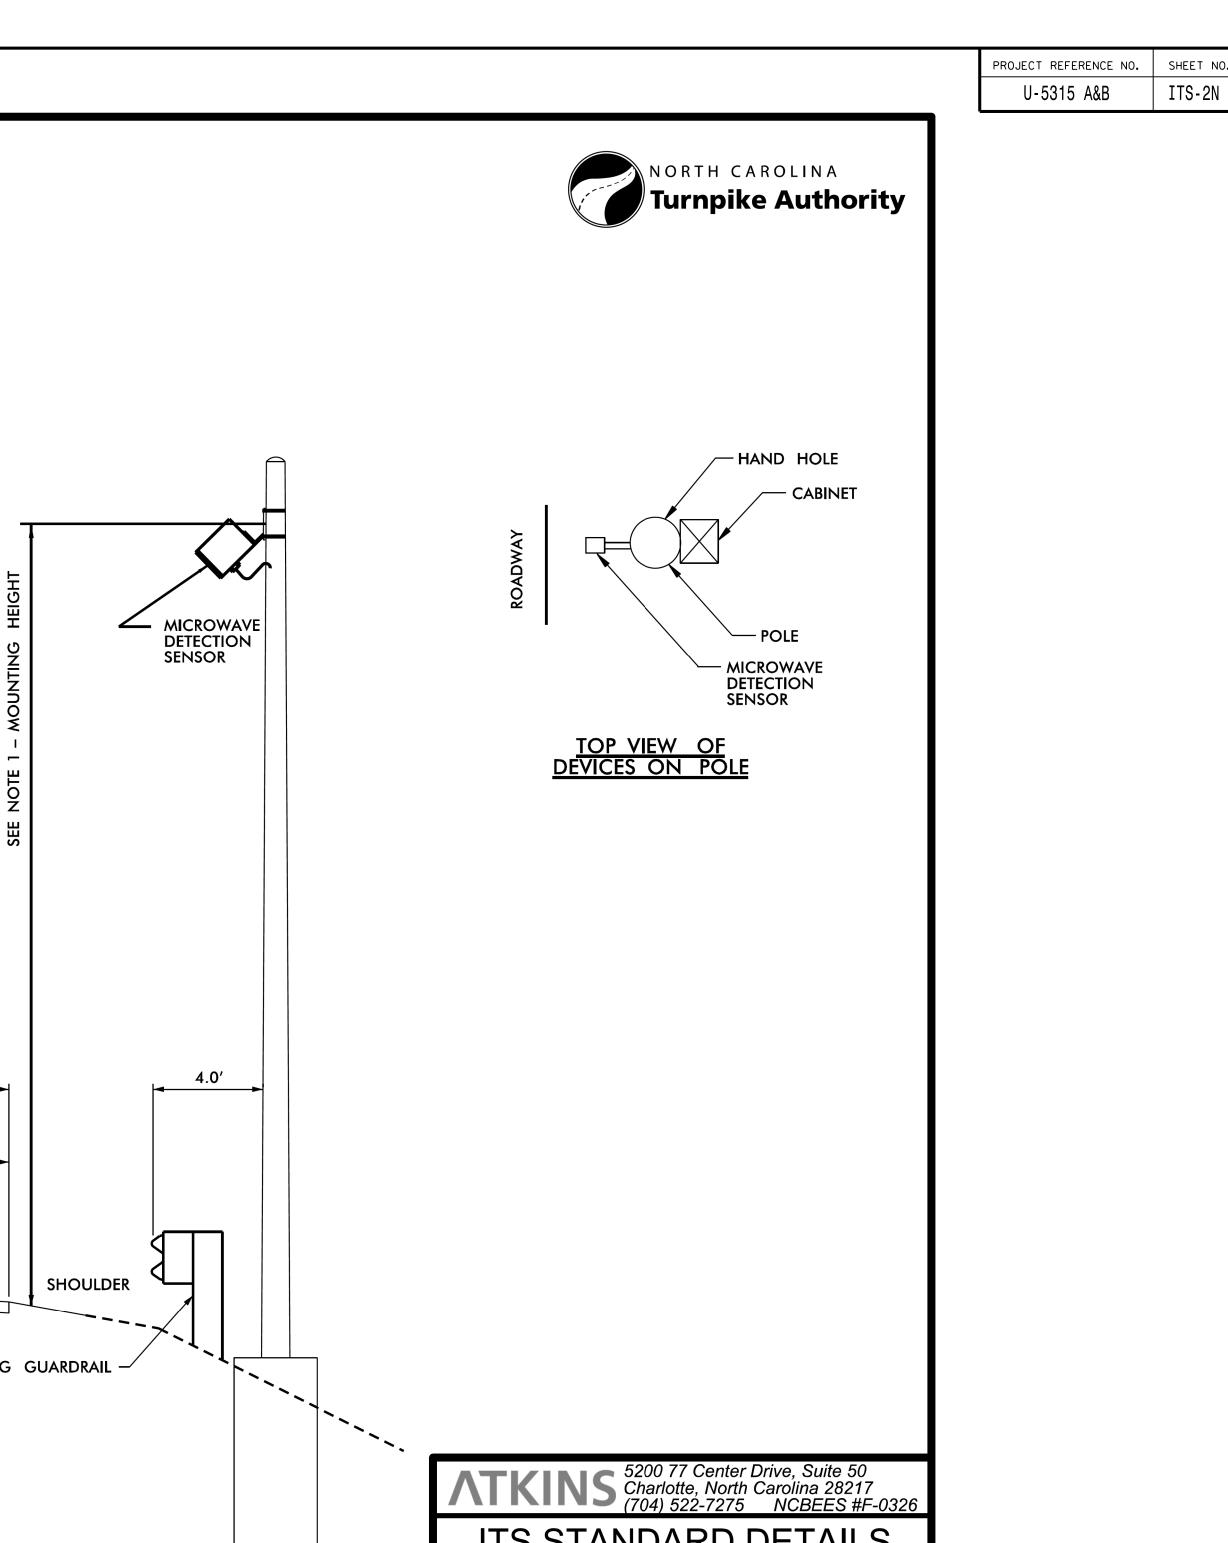



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NORTH CAROLINA TURNPIKE AUTHORITY ITS STANDARD DETAIL

DIVISION 05 WAKE COUNTY TOWN OF CARY
PLAN DATE: NOVEMBER 2017 REVIEWED BY: C.B. HOLDEN
PREPARED BY: D.T. SEARS REVIEWED BY:
REVISIONS INIT. DATE

CADD Filename: U5315_ITS_standarddetails.dg



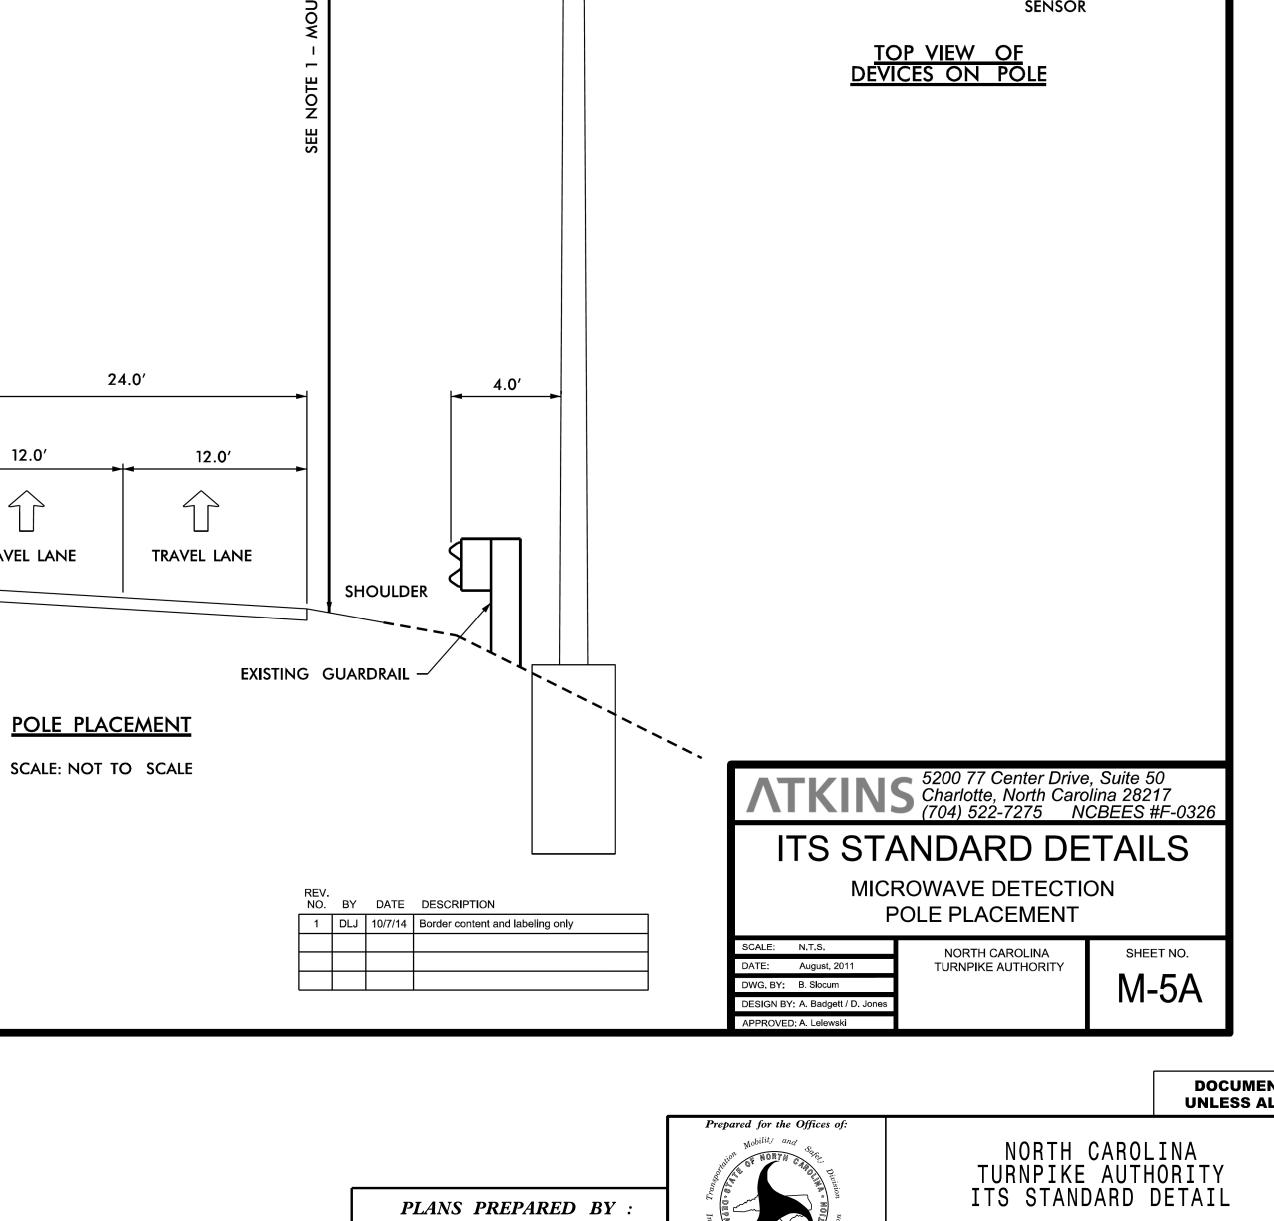

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NC LICENSE NO. F-0112 • (919) 878-9560

24.0'

12.0'

TRAVEL LANE

N/A

DIVISION 05 WAKE COUNTY TOWN OF CARY PLAN DATE: NOVEMBER 2017 REVIEWED BY: C.B. HOLDEN PREPARED BY: D.T. SEARS REVIEWED BY: REVISIONS INIT. DATE

CADD Filename: U5315_ITS_standarddetails.dg

NOTE:

1. LOCATE DETECTOR MOUNTING HEIGHT PER THE

MANUFACTURER'S INSTALLATION GUIDE WITH RESPECT TO HEIGHT, HORIZONTAL SETBACK AND

3. THE CONTRACTOR SHALL SUBMIT SHOP DRAWINGS FOR THE PROPOSED SUPPORT, SIGNED AND SEALED BY A PROFESSIONAL ENGINEER REGISTERED IN THE STATE OF NORTH CAROLINA, TO THE ENGINEER FOR REVIEW AND

4. ALL WORK AND NEW EQUIPMENT SHALL BE DESIGNED AND INSTALLED ACCORDING TO THE REQUIREMENTS

24.0'

POLE PLACEMENT

SCALE: NOT TO SCALE

12.0'

TRAVEL LANE

AND FUNCTIONALITY DESCRIBED IN THE RFP.

12.0'

TRAVEL LANE

MANUFACTURER'S MOUNTING CHART FOR HORIZONTAL SETBACK AND NUMBER OF LANES

2. ALIGN SENSOR MOUNTING ANGLE PER

TO BE DETECTED.

NUMBER OF LANES.

APPROVAL.

MICROWAVE

DETECTION SENSOR

PER CLEAR ZONE REQUIREMENTS

SHOULDER



NOTES:


- 1. NO FIELD WELDING SHALL BE PERMITTED.
- 2. THE CONTRACTOR SHALL SUBMIT SHOP DRAWINGS FOR THE PROPOSED SUPPORT, SIGNED AND SEALED BY A PROFESSIONAL ENGINEER REGISTERED IN THE STATE OF NORTH CAROLINA, TO THE ENGINEER FOR REVIEW AND APPROVAL.

3/4" X 0.025" MIN. SS ROUND-EDGE STRAP WITH ULTIMATE BREAKING STRENGTH — OF 1500 LBS. MIN. TWO STRAPS REQ'D PER CHANNEL BRACKET. (TIGHTENED TO 100 LB. TENSION WITHOUT SLIPPAGE EACH

3. MOUNTING BRACKET CONNECTION TO POLE SHALL ALLOW ADJUSTMENT OF TILT ANGLE.

STRAP)

4. ALL WORK AND NEW EQUIPMENT SHALL BE DESIGNED AND INSTALLED ACCORDING TO THE REQUIREMENTS AND FUNCTIONALITY DESCRIBED IN THE RFP.

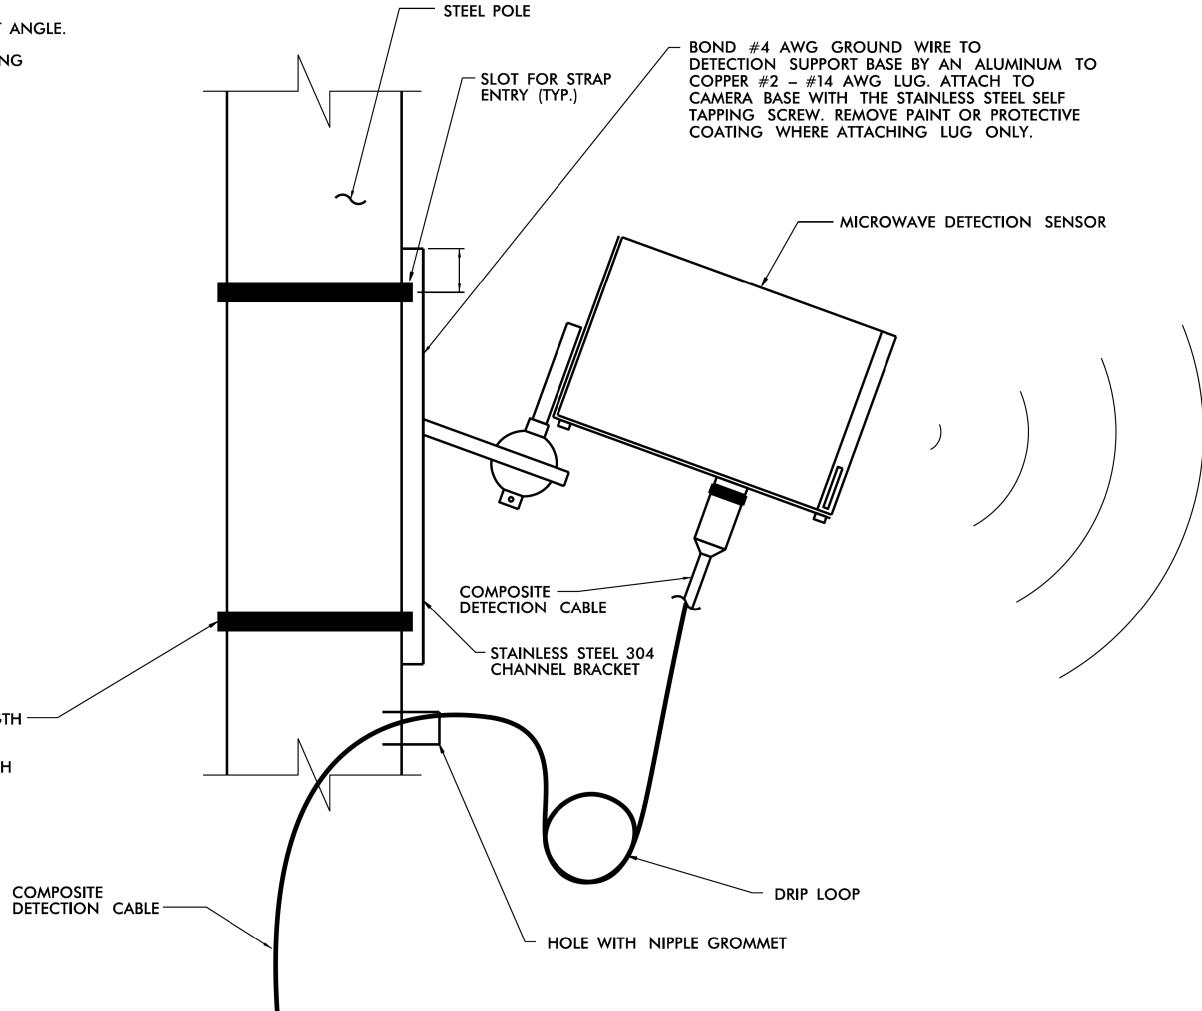

MICROWAVE DETECTION SENSOR ELEVATION VIEW

NOT TO SCALE

REV. NO.	BY	DATE	DESCRIPTION
1	DLJ	10/7/14	Border content and labeling only

REVISED 10 /21 /2011

TKINS 5200 77 Center Drive, Suite 50 Charlotte, North Carolina 28217 (704) 522-7275 NCBEES #F-0326 ITS STANDARD DETAILS

> MICROWAVE DETECTION SENSOR MOUNTING

DATE: August, 2011 DWG. BY: B. Slocum DESIGN BY: A. Badgett / D. Jones

APPROVED; A. Lelewski


NORTH CAROLINA TURNPIKE AUTHORITY

SHEET NO.

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NC LICENSE NO. F-0112 • (919) 878-9560



N/A

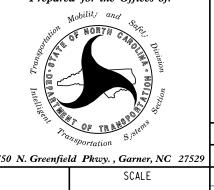NORTH CAROLINA TURNPIKE AUTHORITY ITS STANDARD DETAIL


DIVISION 05 WAKE COUNTY TOWN OF CARY PLAN DATE: NOVEMBER 2017 REVIEWED BY: C.B. HOLDEN PREPARED BY: D.T. SEARS REVIEWED BY: REVISIONS INIT. DATE

CADD Filenome: U5315_ITS_standarddetails.dg

PROJECT REFERENCE NO. ITS-2P U-5315 A&B

NORTH CAROLINA

Turnpike Authority

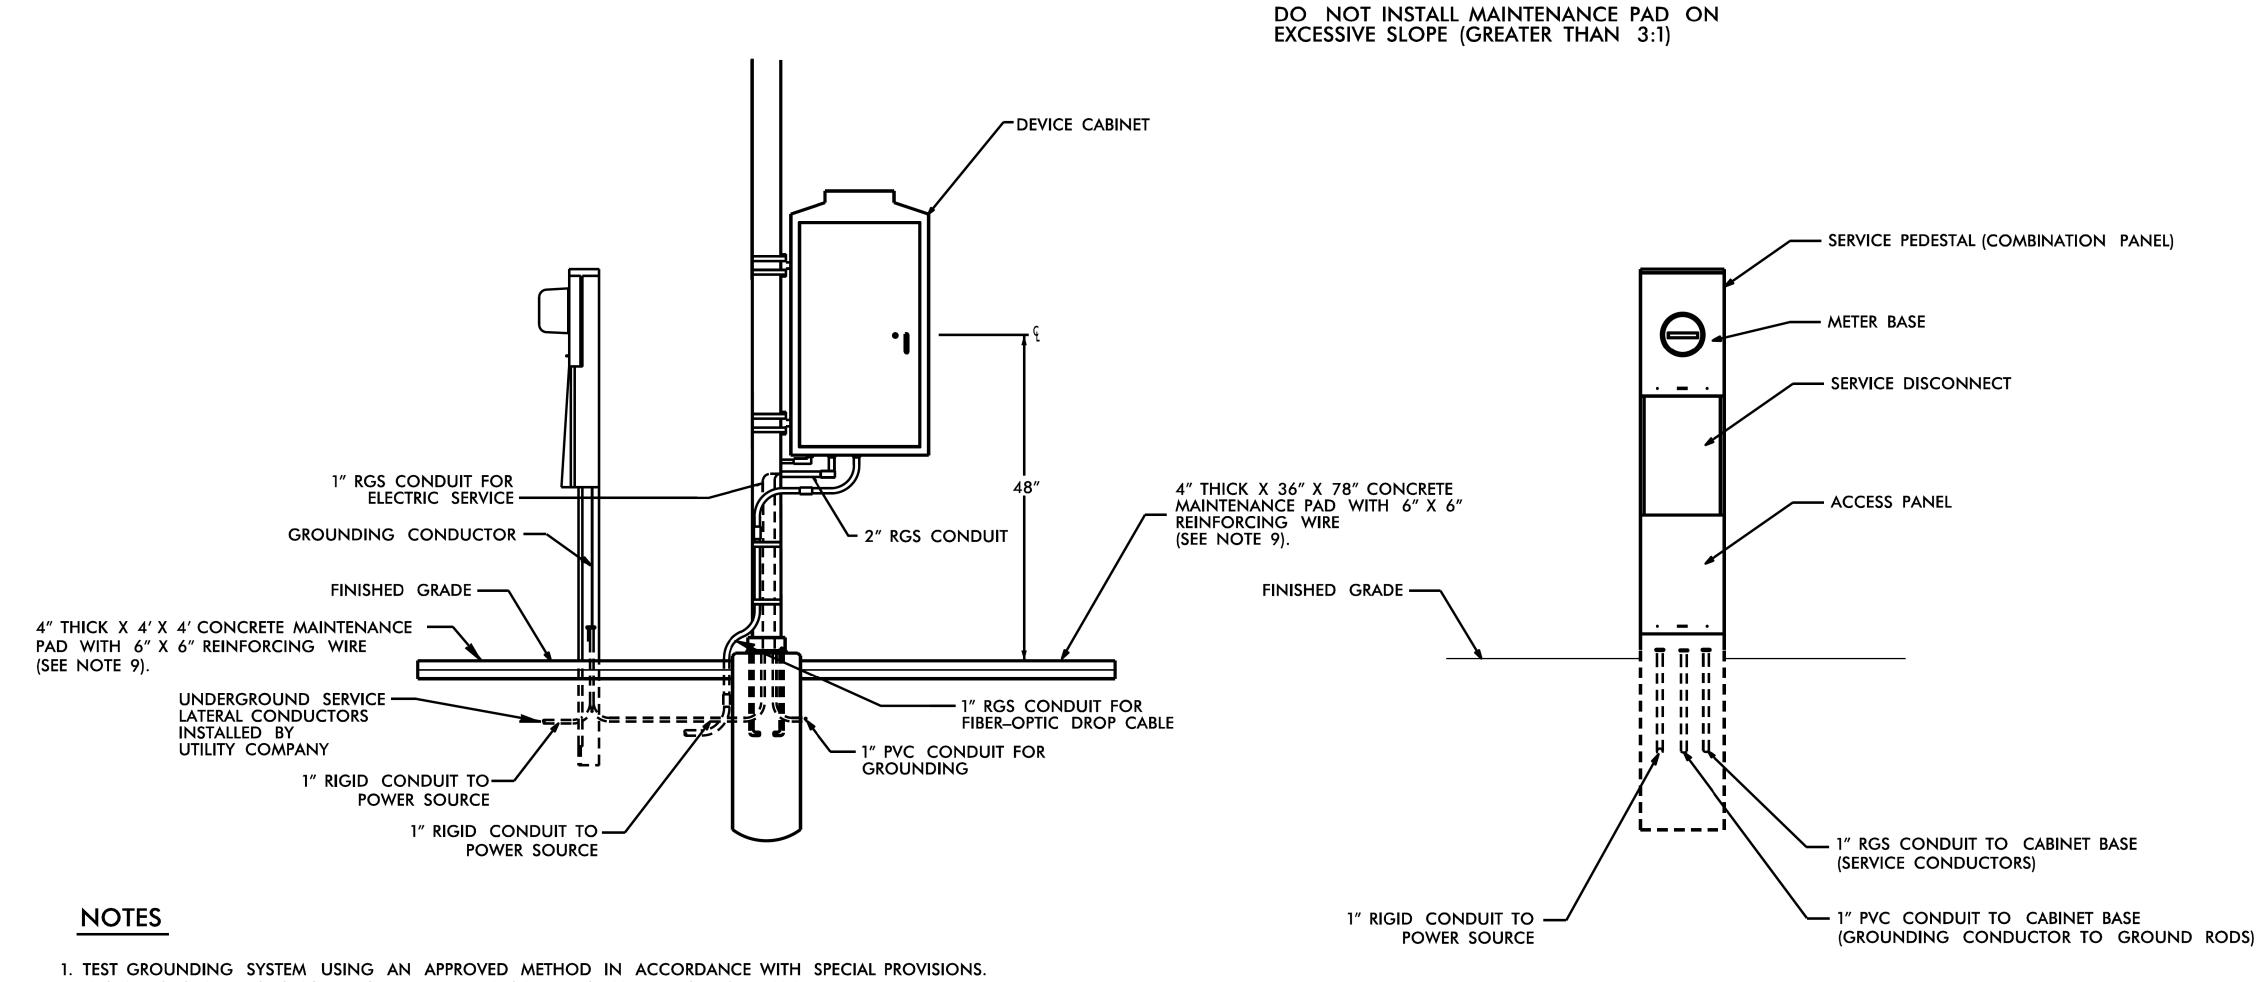

INSTALL GROUND RODS AS DIRECTED BY THE ENGINEER TO MEET THIS REQUIREMENT.

- 2. REMOVE ANY EXISTING GROUND RODS IN CONCRETE CABINET FOUNDATION BY CUTTING OFF FLUSH WITH FOUNDATION SURFACE.
- 3. REMOVE BONDING JUMPER IN EQUIPMENT CABINET IF INSTALLED BETWEEN AC NEUTRAL AND EQUIPMENT GROUND.
- 4. BOND ALL RIGID GALVANIZED STEEL CONDUITS ENTERING THE CABINET TO "EQUIPMENT GROUND".
- 5. INSTALL RIGID GALVANIZED STEEL CONDUIT (MINIMUM 1") BETWEEN DISCONNECT AND CABINET.
- 7. IF CONDITIONS REQUIRE SERVICE PEDESTAL TO BE INSTALLED IN FRONT OR REAR OF

6. SERVICE DISCONNECT GROUND BUS BAR SHALL PROVIDE FOR 2 #4 AWG CONNECTIONS.

- CABINET, MAINTAIN SUFFICIENT CLEARANCE FOR DOOR TO FULLY OPEN.
- 8. ALL WORK AND NEW EQUIPMENT SHALL BE DESIGNED AND INSTALLED ACCORDING TO THE REQUIREMENTS AND FUNCTIONALITY DESCRIBED IN THE RFP.
- CONCRETE PADS FOR SERVICE PEDESTAL AND CABINET SHALL BE COMBINED TO A STREET TO., NEXT TO POLE. COMBINATION PANELS NOT ADJACENT TO CABINETS DO NOT REQUIRE A MAINTENANCE PAD. 9. CONCRETE PADS FOR SERVICE PEDESTAL AND CABINET SHALL BE COMBINED INTO A SINGLE PAD, IF PEDESTAL IS PRESENT

REVISED 8 / 24 / 11

FINS 5200 77 Center Drive, Suite 50 Charlotte, North Carolina 28217 (704) 522-7275 NCBEES #F-0326 ITS STANDARD DETAILS

POWER SERVICE DETAIL POLE-MOUNTED CABINET


SCALE: N.T.S. DATE: August, 2011 DWG, BY: B. Slocum DESIGN BY: A. Badgett / D. Jones

APPROVED; A. Lelewski

NORTH CAROLINA TURNPIKE AUTHORITY

SHEET NO. P-2

> DOCUMENT NOT CONSIDERED FINAL **UNLESS ALL SIGNATURES COMPLETED**

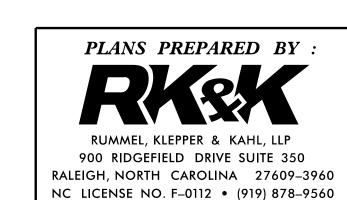

REV. NO. BY DATE DESCRIPTION

1 DLJ 10/7/14 Meter pad, border content




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NORTH CAROLINA TURNPIKE AUTHORITY ITS STANDARD DETAIL

DIVISION 05 WAKE COUNTY TOWN OF CARY PLAN DATE: NOVEMBER 2017 REVIEWED BY: C.B. HOLDEN PREPARED BY: D.T. SEARS REVIEWED BY: REVISIONS INIT. DATE

CADD Filenome: U5315_ITS_standarddetails.dg

PROJECT REFERENCE NO. ITS-3A U-5315 A&B

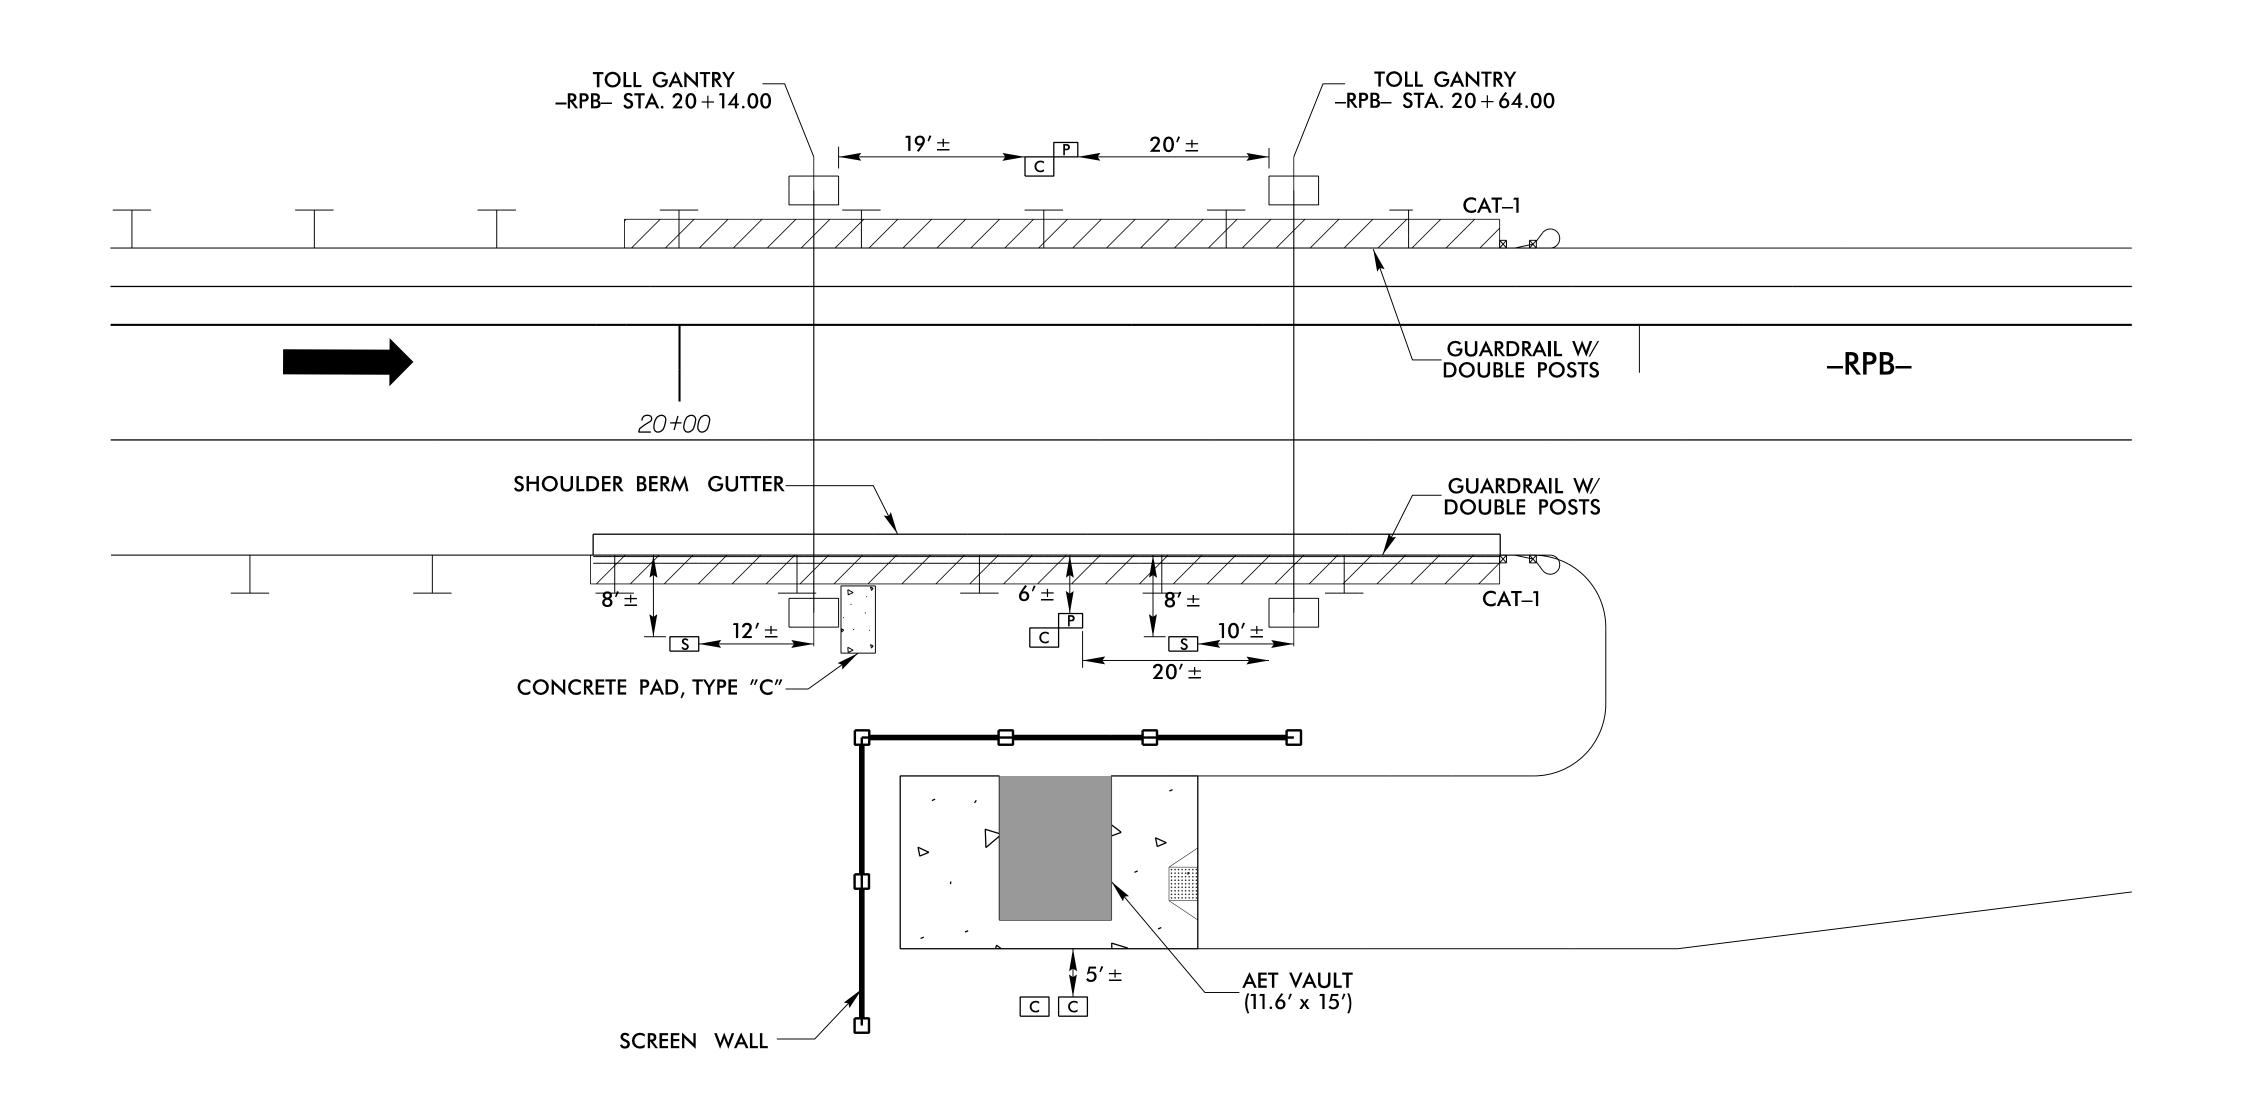

DOCUMENT NOT CONSIDERED FINAL UNLESS ALL SIGNATURES COMPLETED MORRISVILLE PARKWAY TOLL SITE AET T16 CONCRETE PAD AND JUNCTION SEAL 033753

BOX LOCATION DETAILS DIVISION 05 WAKE COUNTY 750 N. Greenfield Pkwy., Garner, NC 27529 PREPARED BY: L.A. TUTT REVIEWED BY:

PLANS PREPARED BY :

RUMMEL, KLEPPER & KAHL, LLP


900 RIDGEFIELD DRIVE SUITE 350 RALEIGH, NORTH CAROLINA 27609-3960 NC LICENSE NO. F-0112 • (919) 878-9560


TOWN OF CARY PLAN DATE: NOVEMBER 2017 REVIEWED BY: C.B. HOLDEN REVISIONS INIT. DATE C. Byron Holden

CADD Filename: U5315_ITS_PSH03A.dgn

NOTES: 1. FINAL LOOP SPLICE BOX LOCATIONS TO BE DETERMINED AFTER CONSULTATION WITH TOLL SYSTEMS INTEGRATOR.


2. ADD CONCRETE APRONS TO BOXES AS SHOWN IN AET-11.

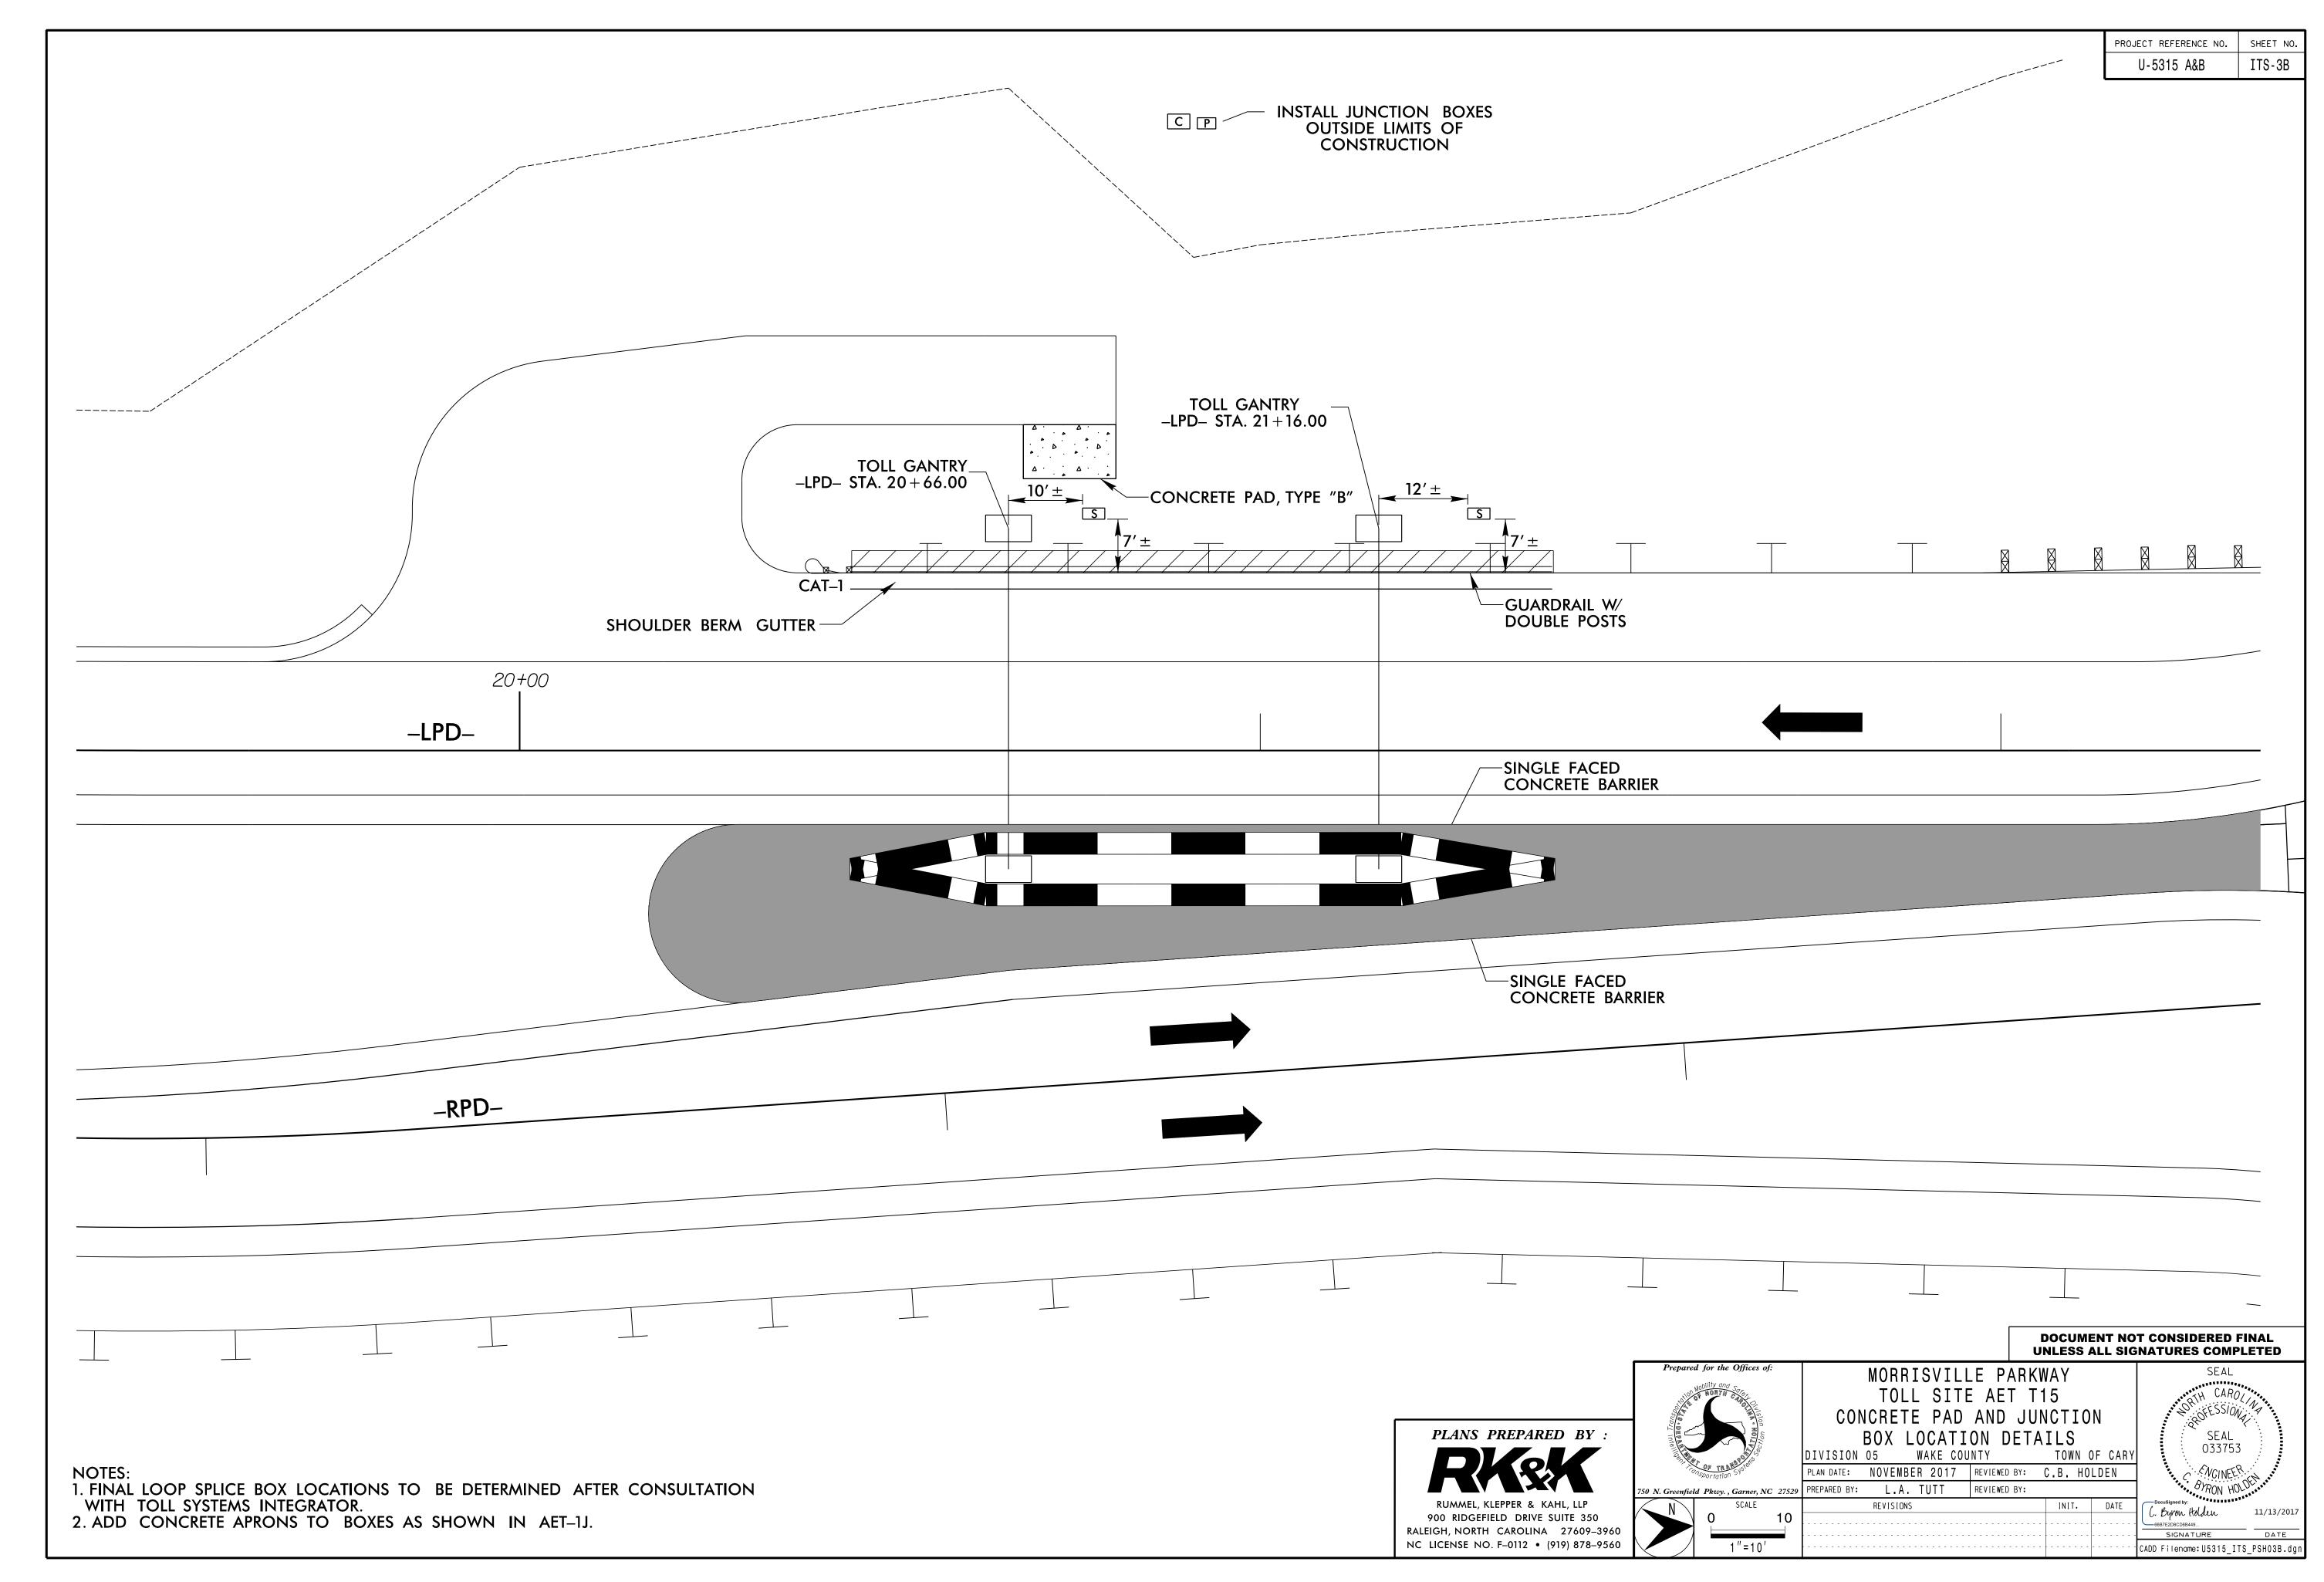

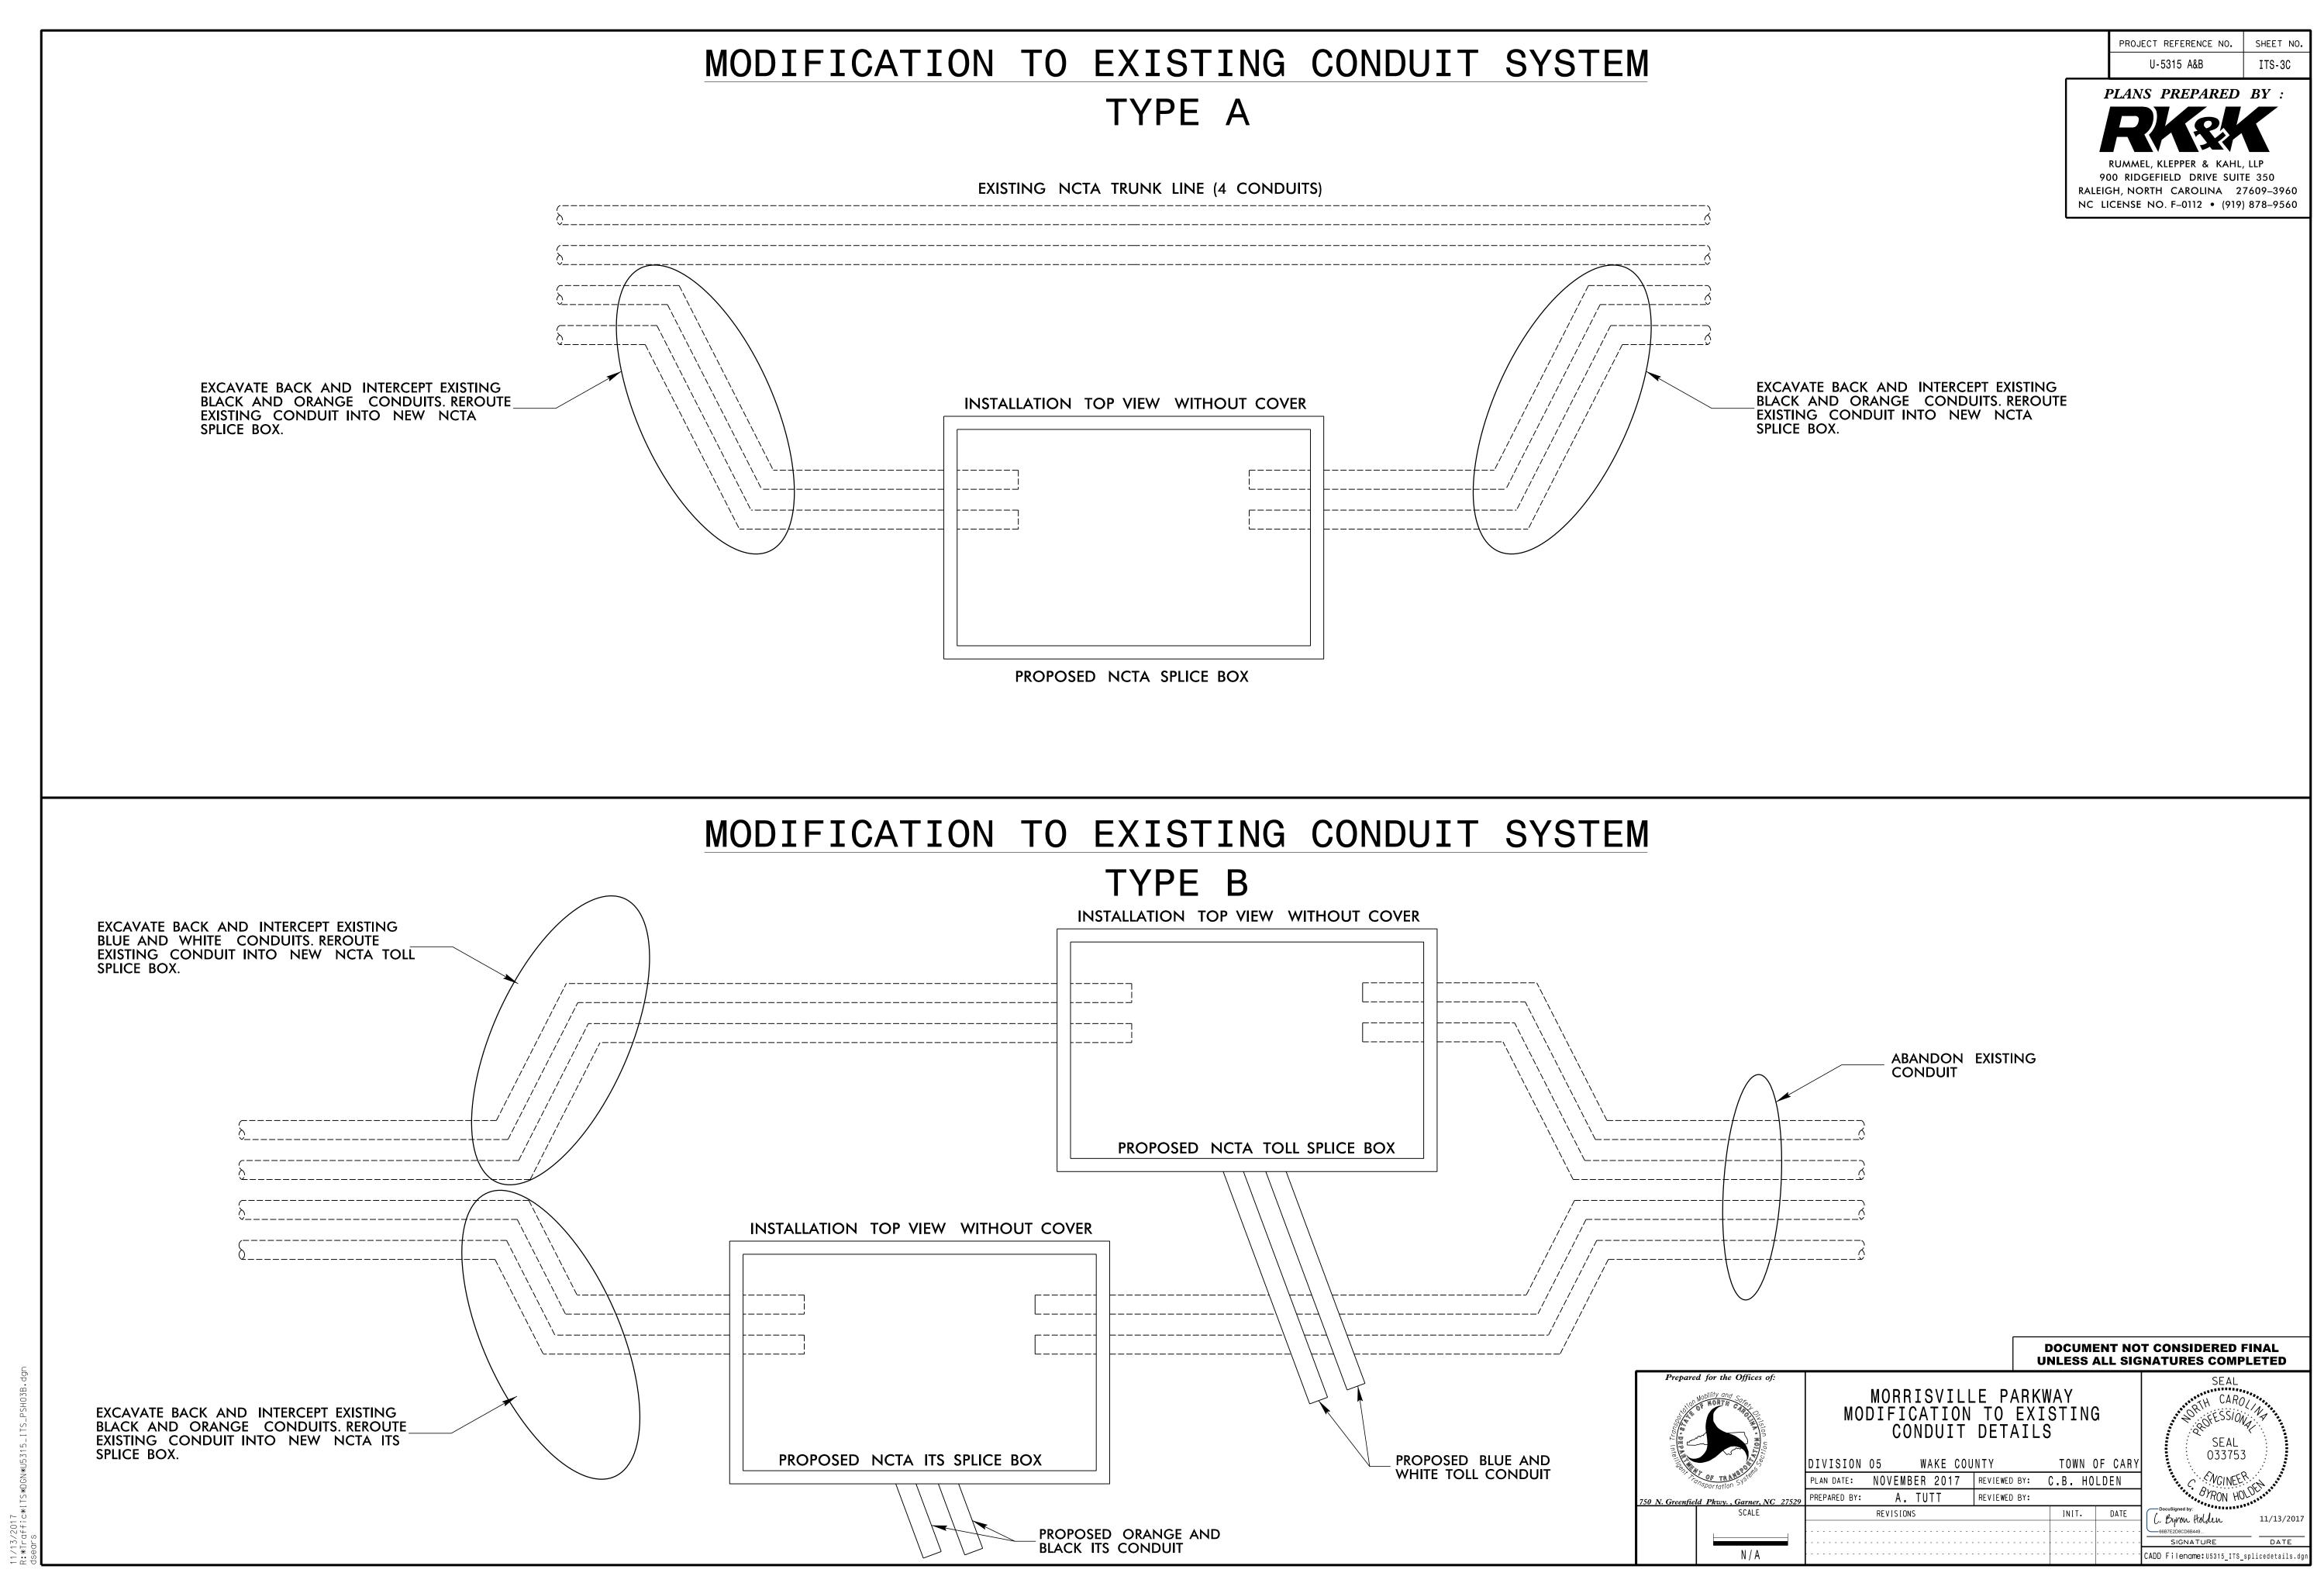

PROJECT REFERENCE NO. SHEET NO. U-5315 A&B ITS-3D

MODIFICATION TO EXISTING CONDUIT SYSTEM TYPE C

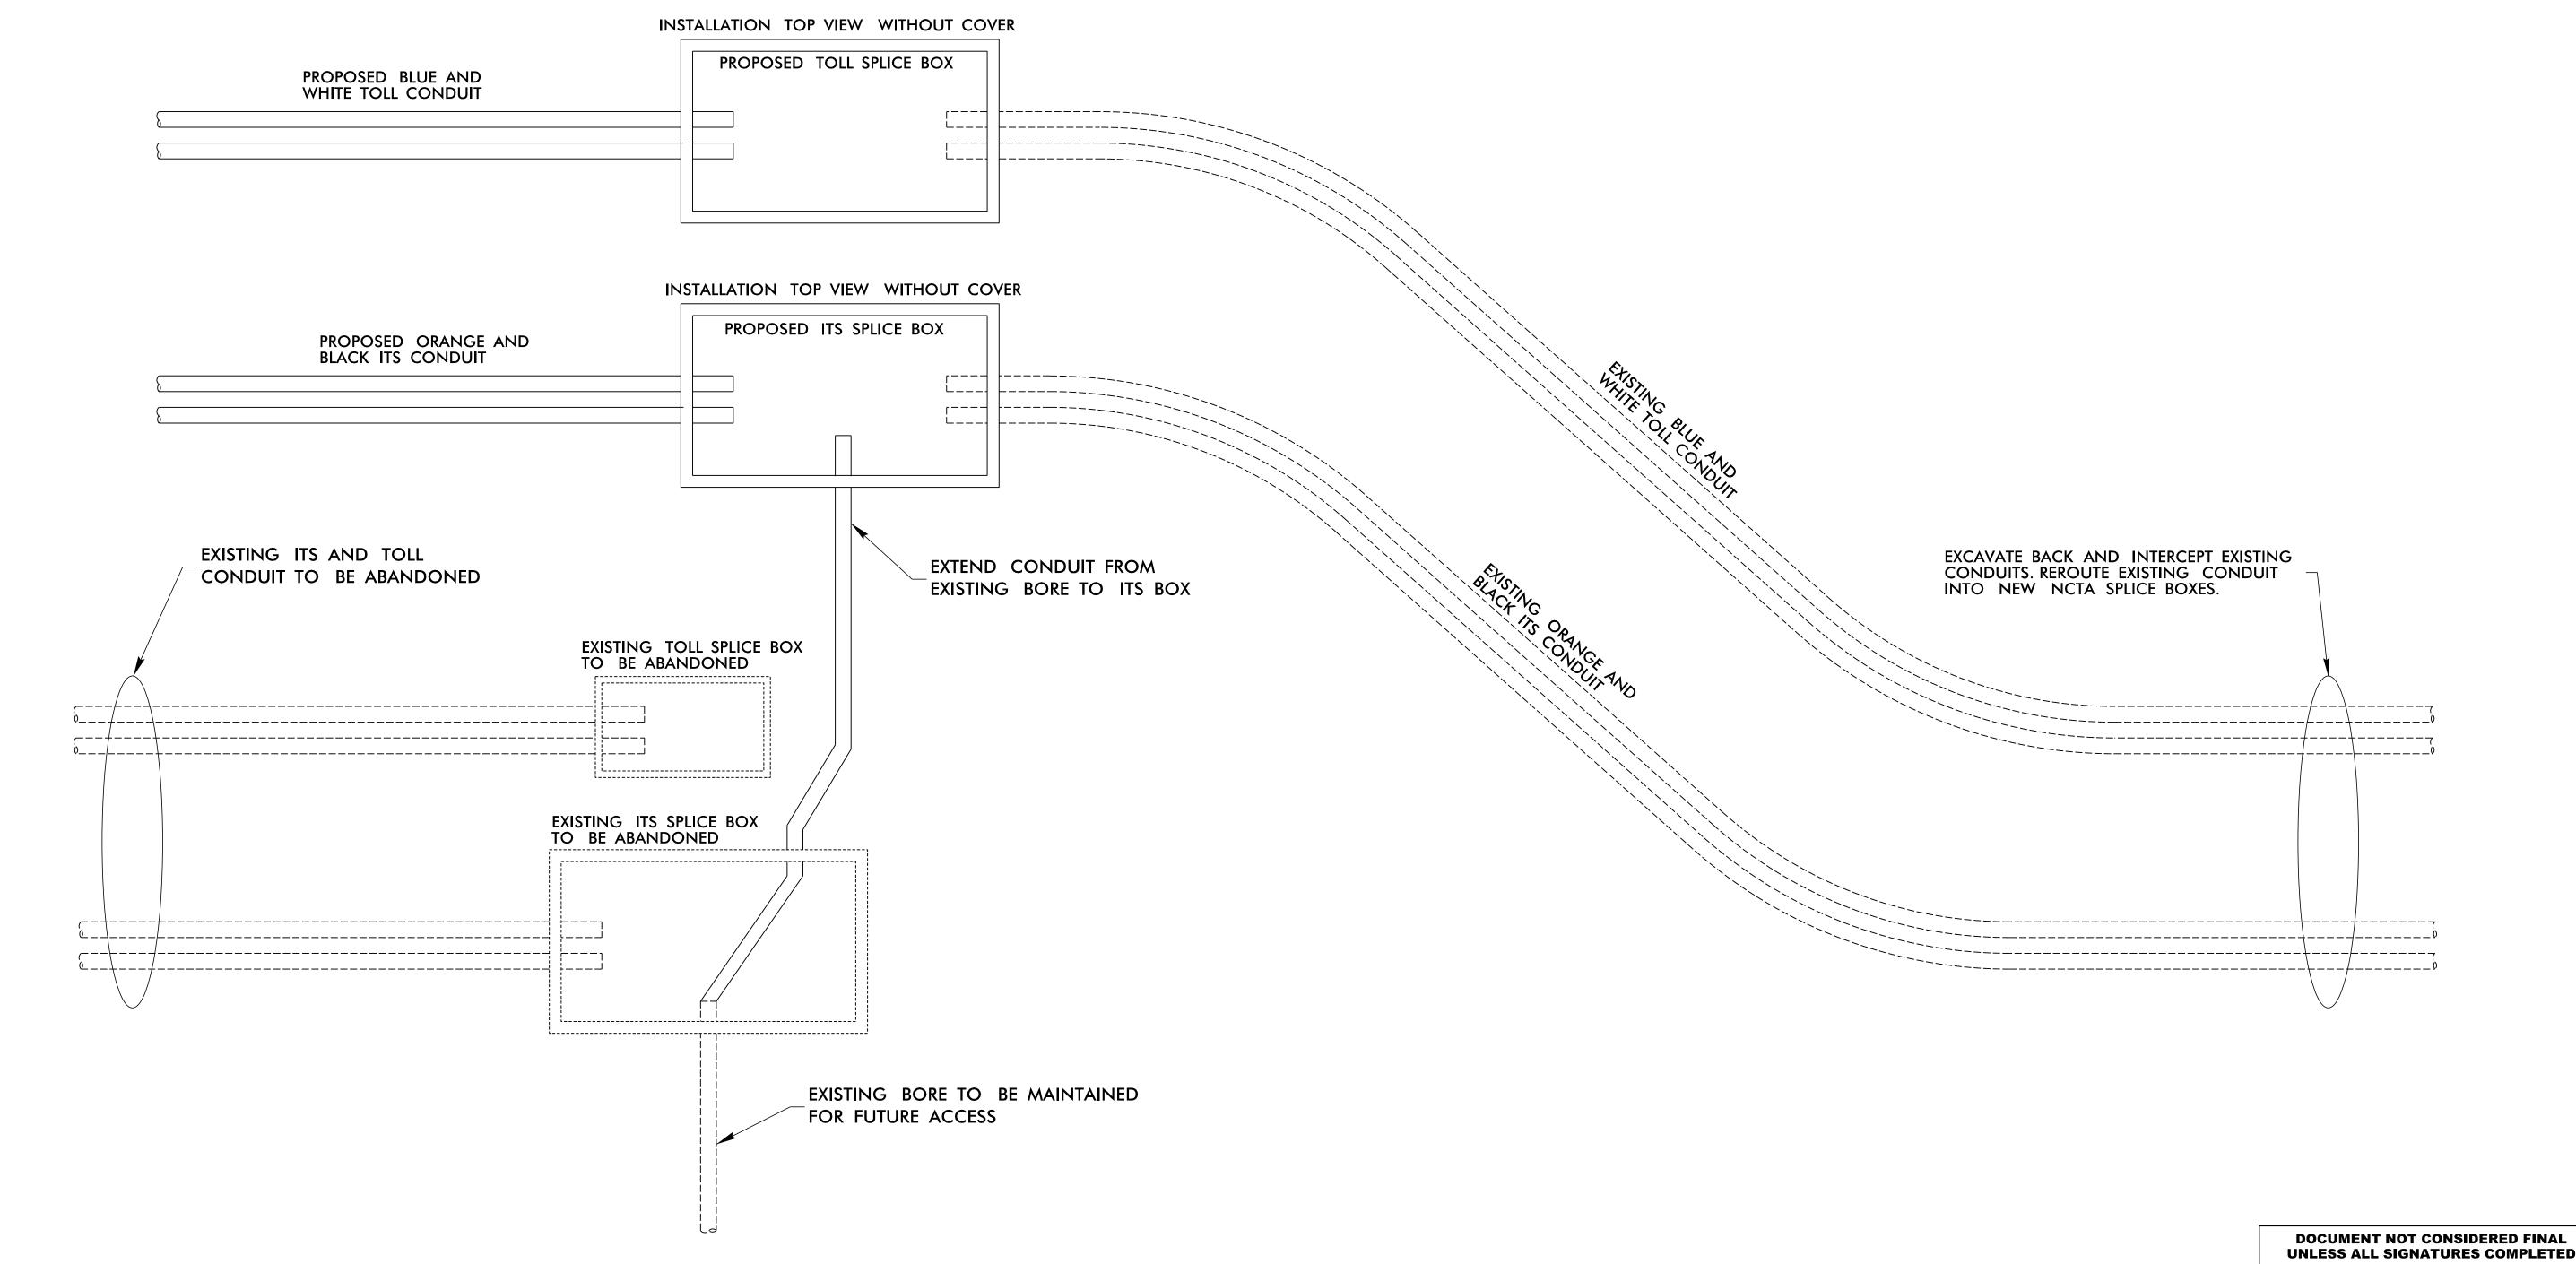

NOTES:

CONTRACTOR TO COORDINATE MODIFICATION TO EXISTING CONDUIT SYSTEM WITH THE GRADING OPERATION TO ENSURE NO DAMAGE TO THE EXISTING FIBER OPTIC TRUNK LINE. SEE TRANSPORATION MANAGEMENT PLAN FOR CONSTRUCTION PHASING.



Prepared for the Offices of:

MORRISVILLE PARKWAY MODIFICATION TO EXISTING CONDUIT DETAILS

DIVISION 05 WAKE COUNTY TOWN OF CARY
PLAN DATE: DECEMBER 2017 REVIEWED BY: C.B. HOLDEN
PREPARED BY: A. TUTT REVIEWED BY:

SCALE REVISIONS INIT. DATE

N/A





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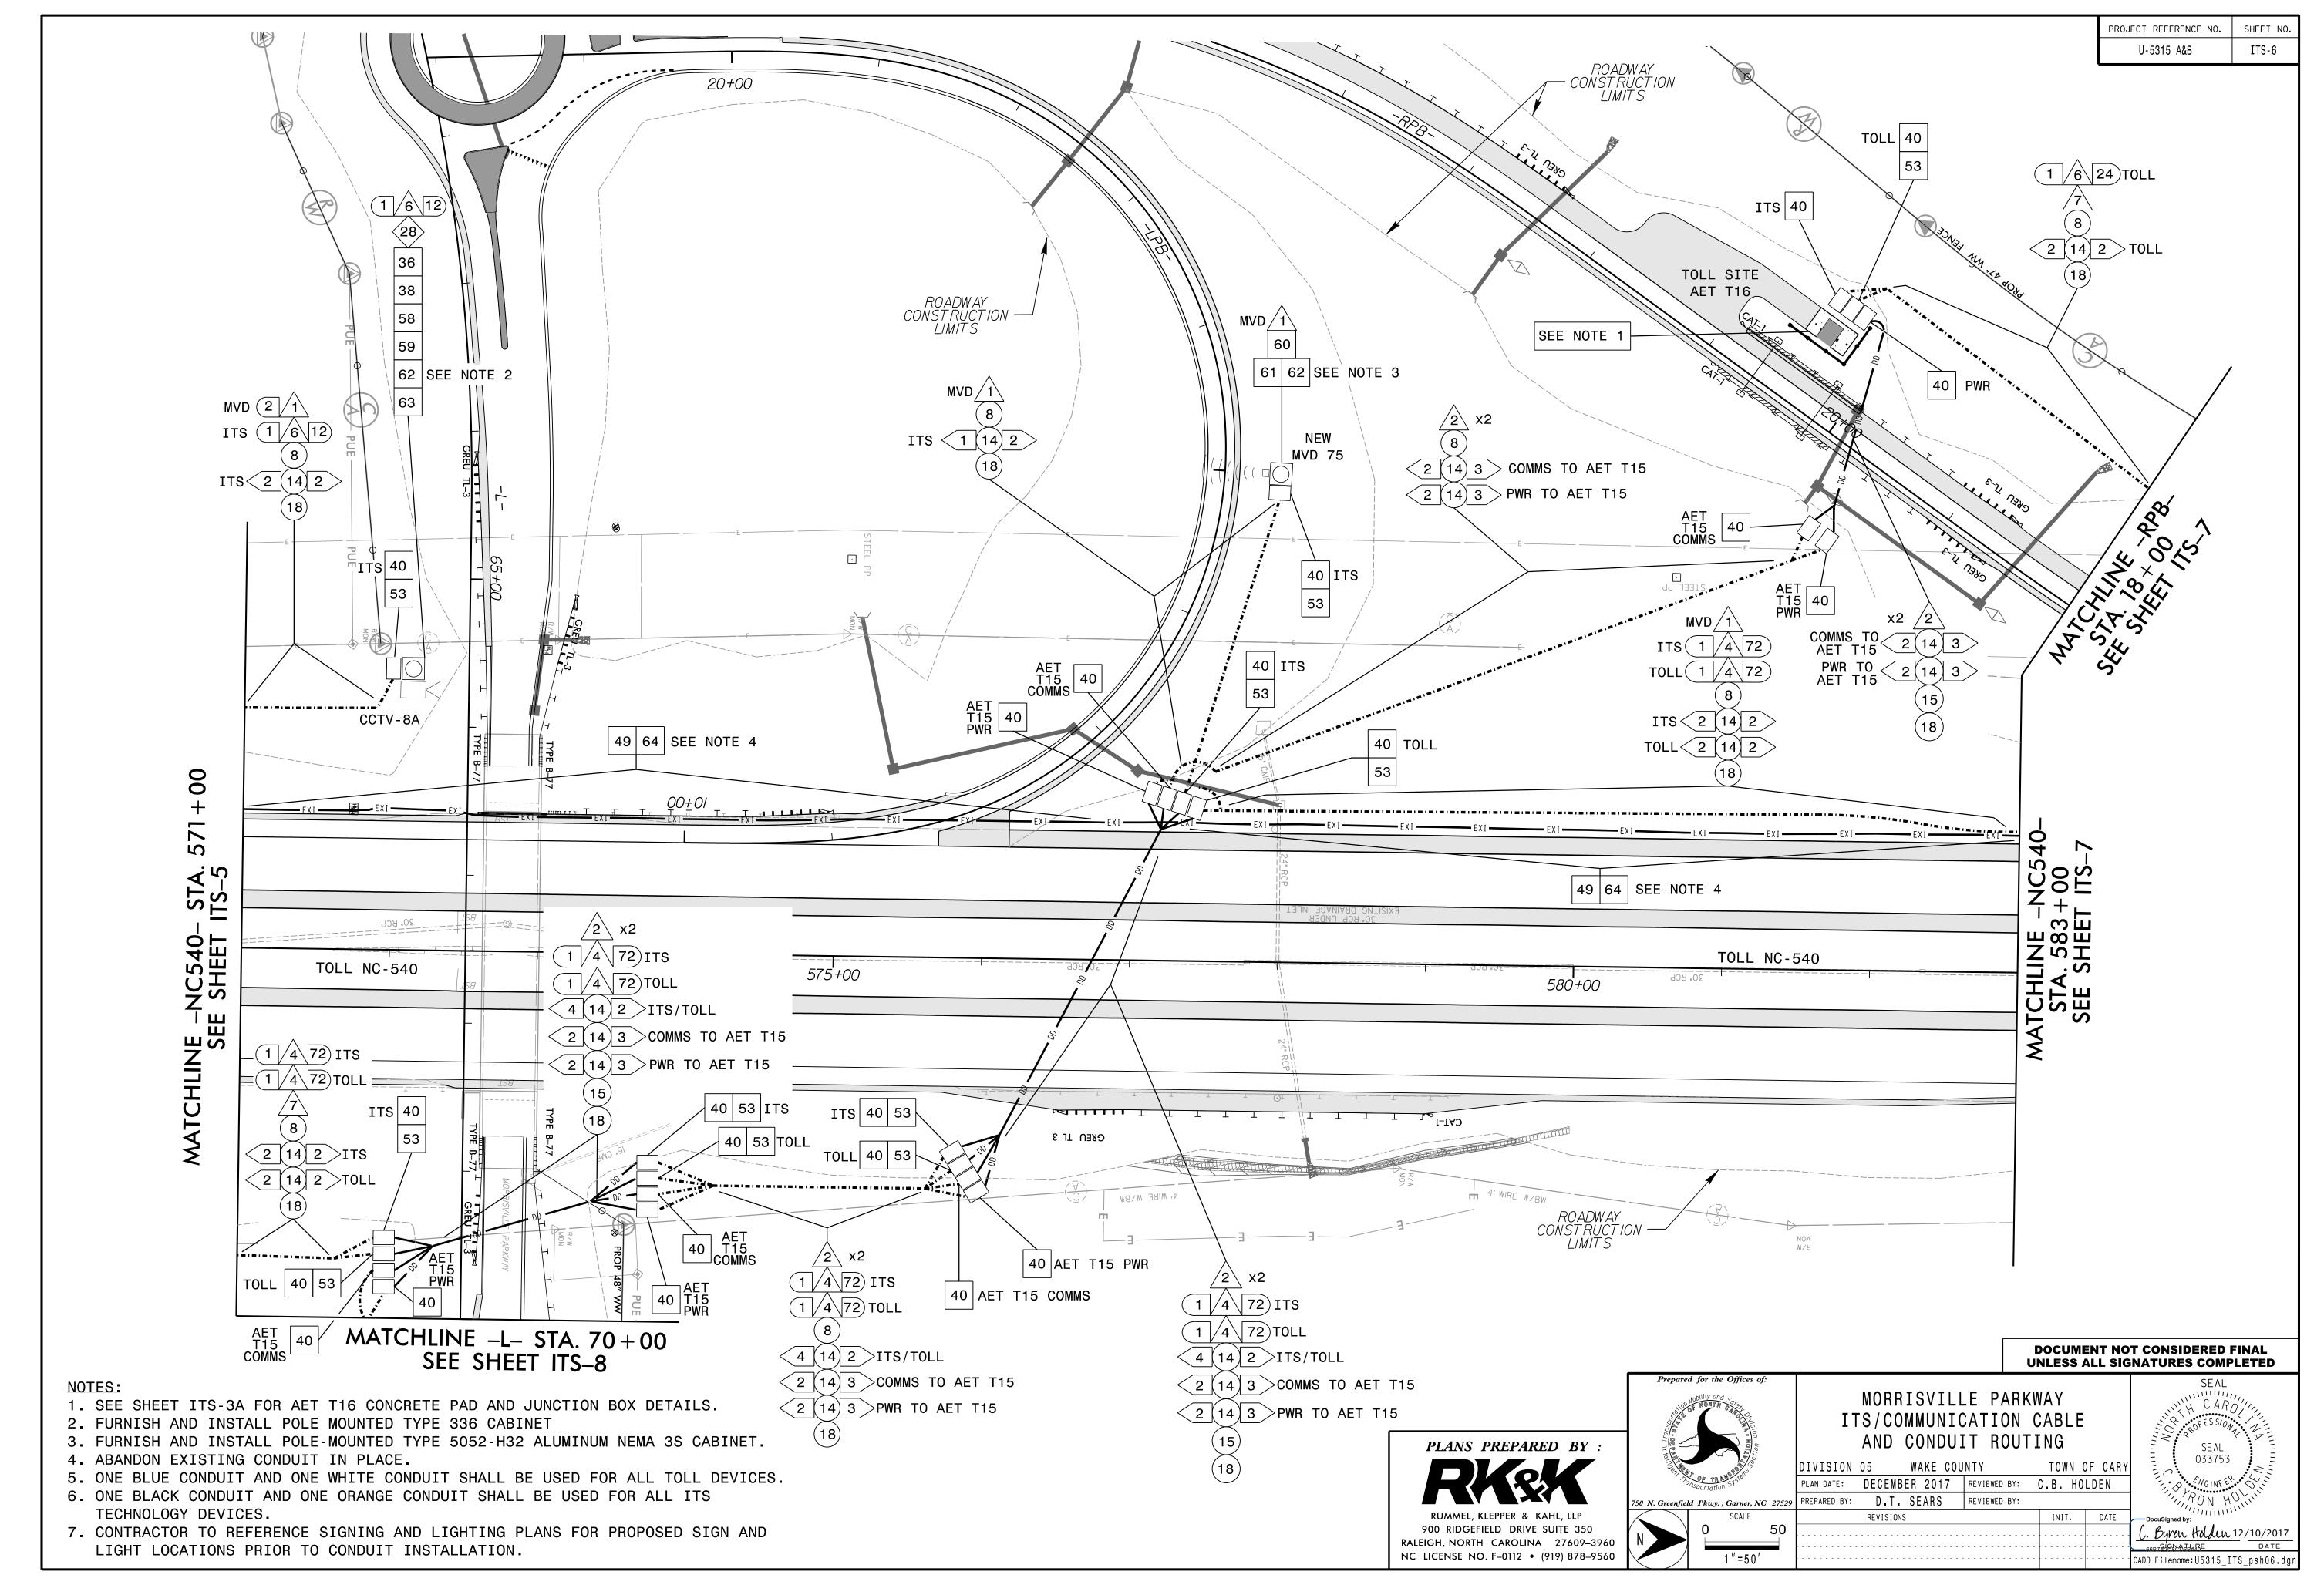
C. Byron Holden 12/10/2017

668\$#QN\$\(\text{O}\) DATE

CADD Filename: U5315_ITS_splicedetails.dgn




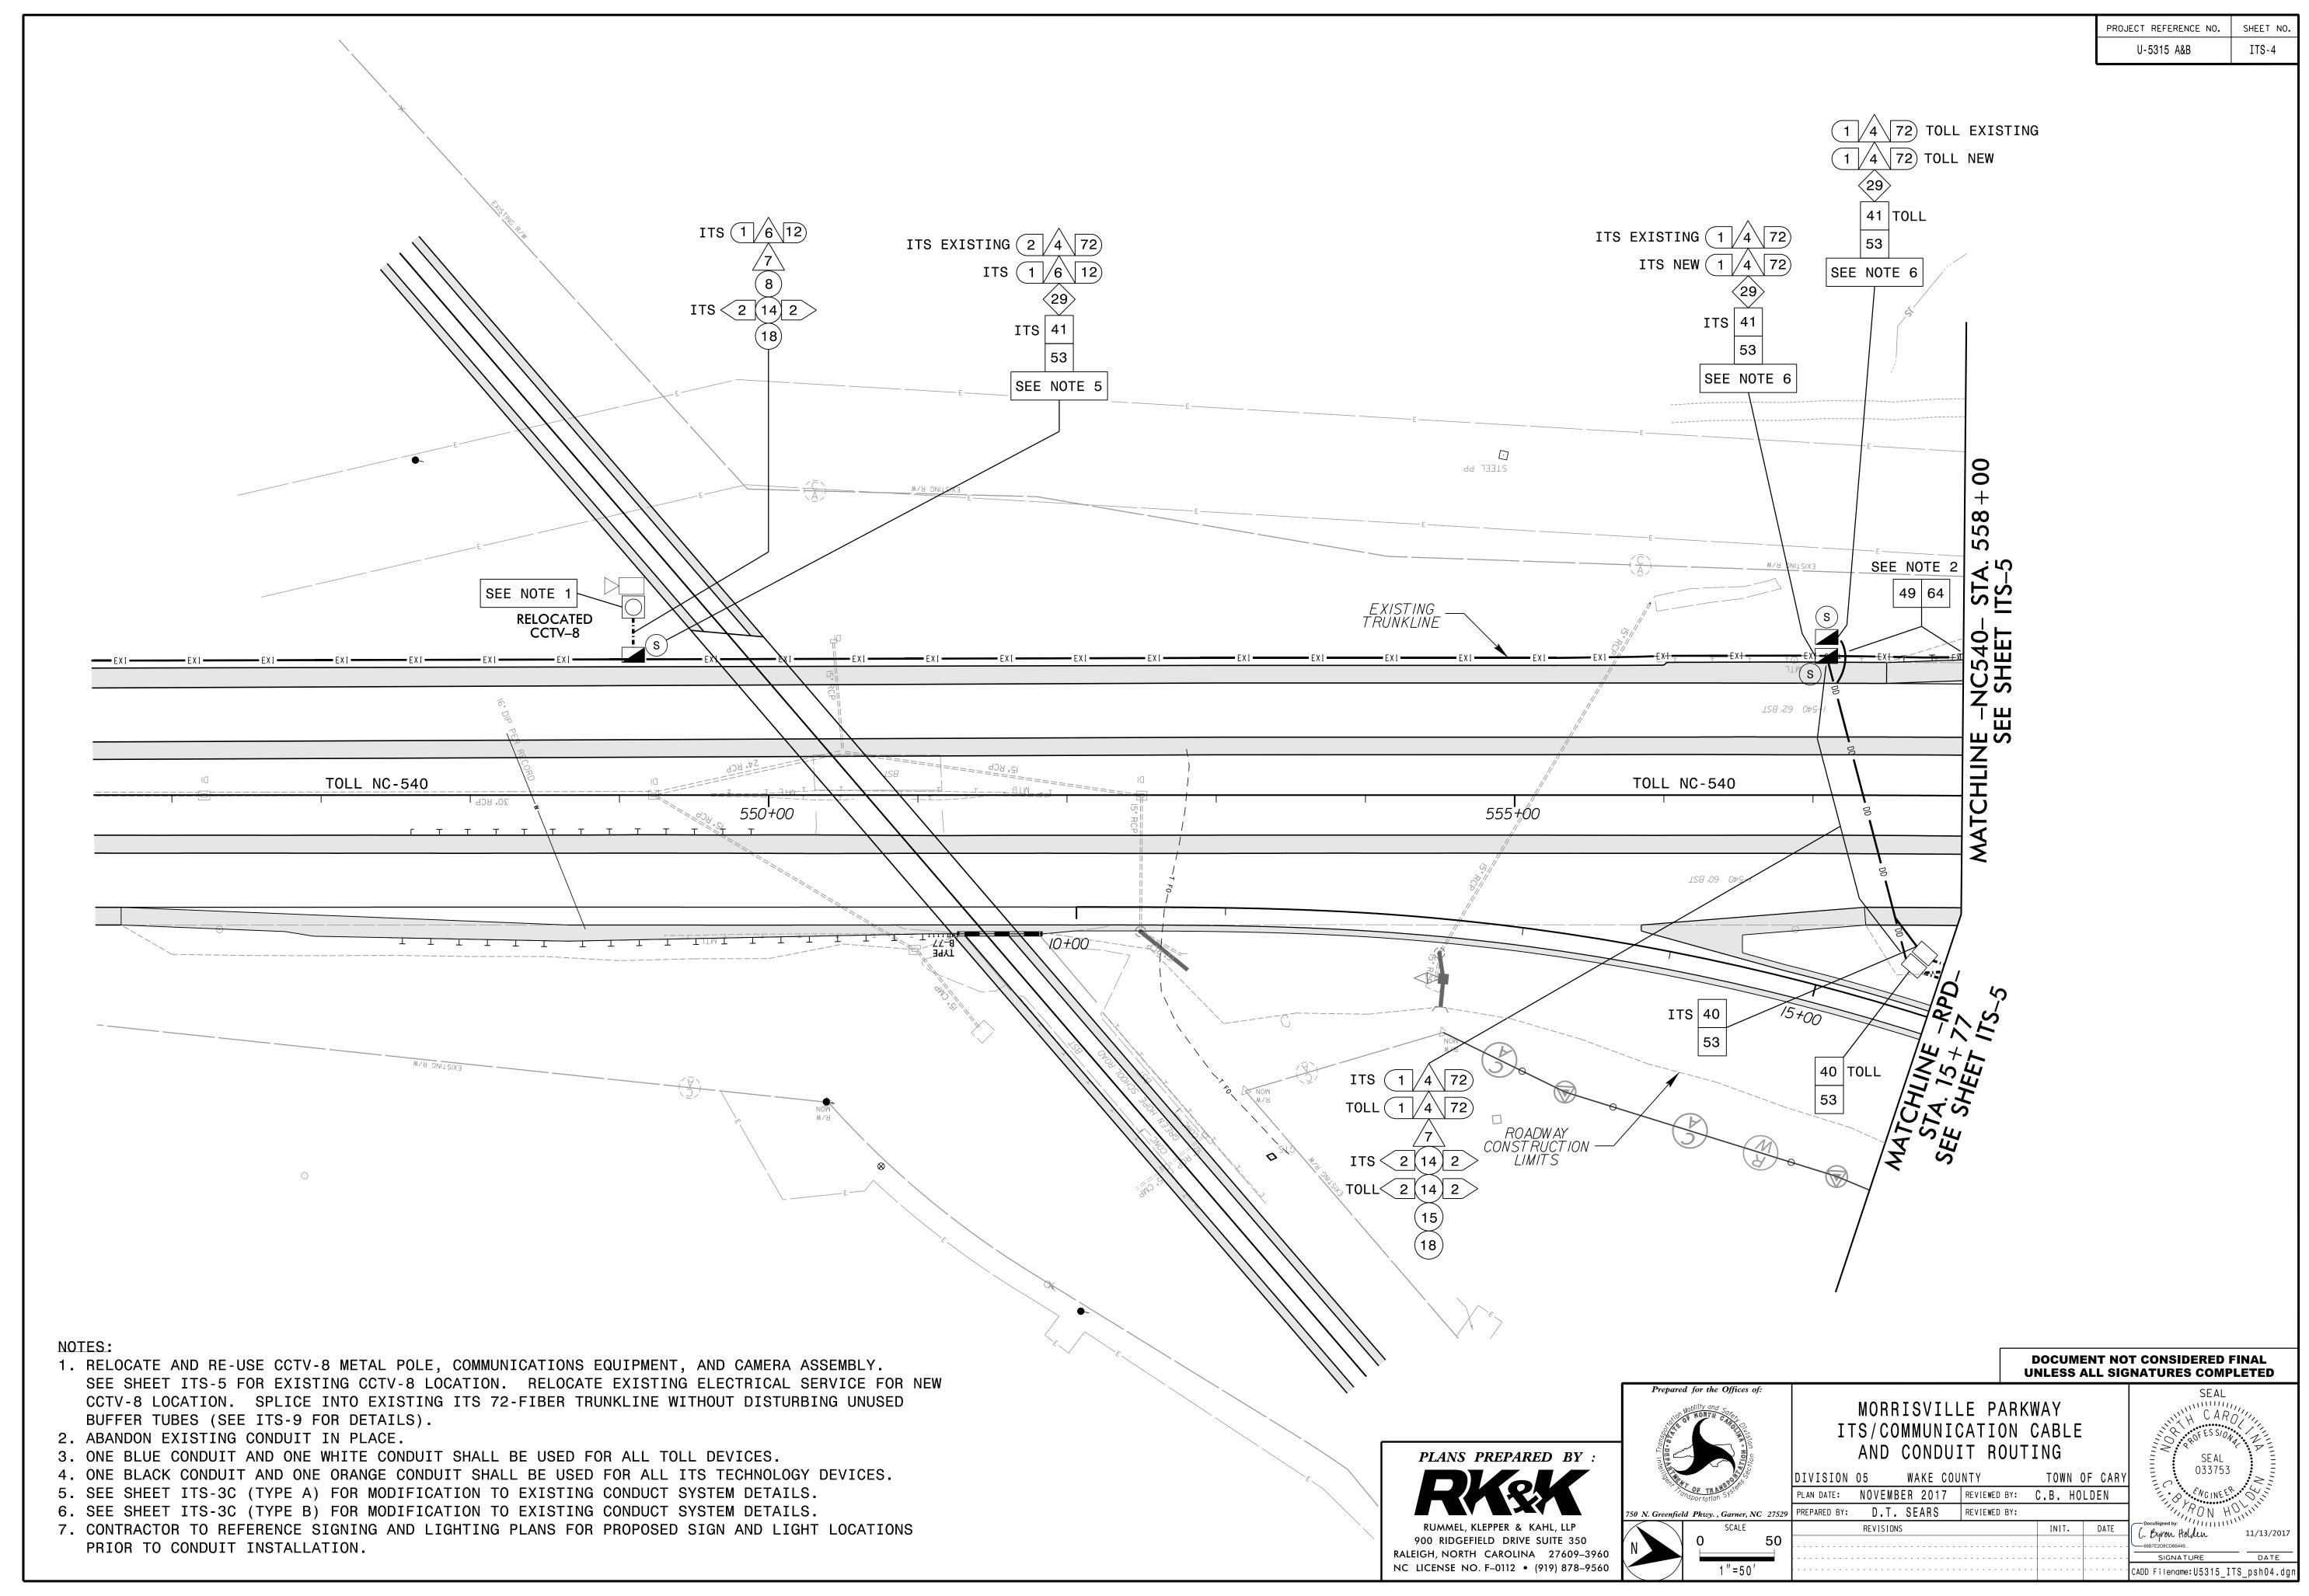

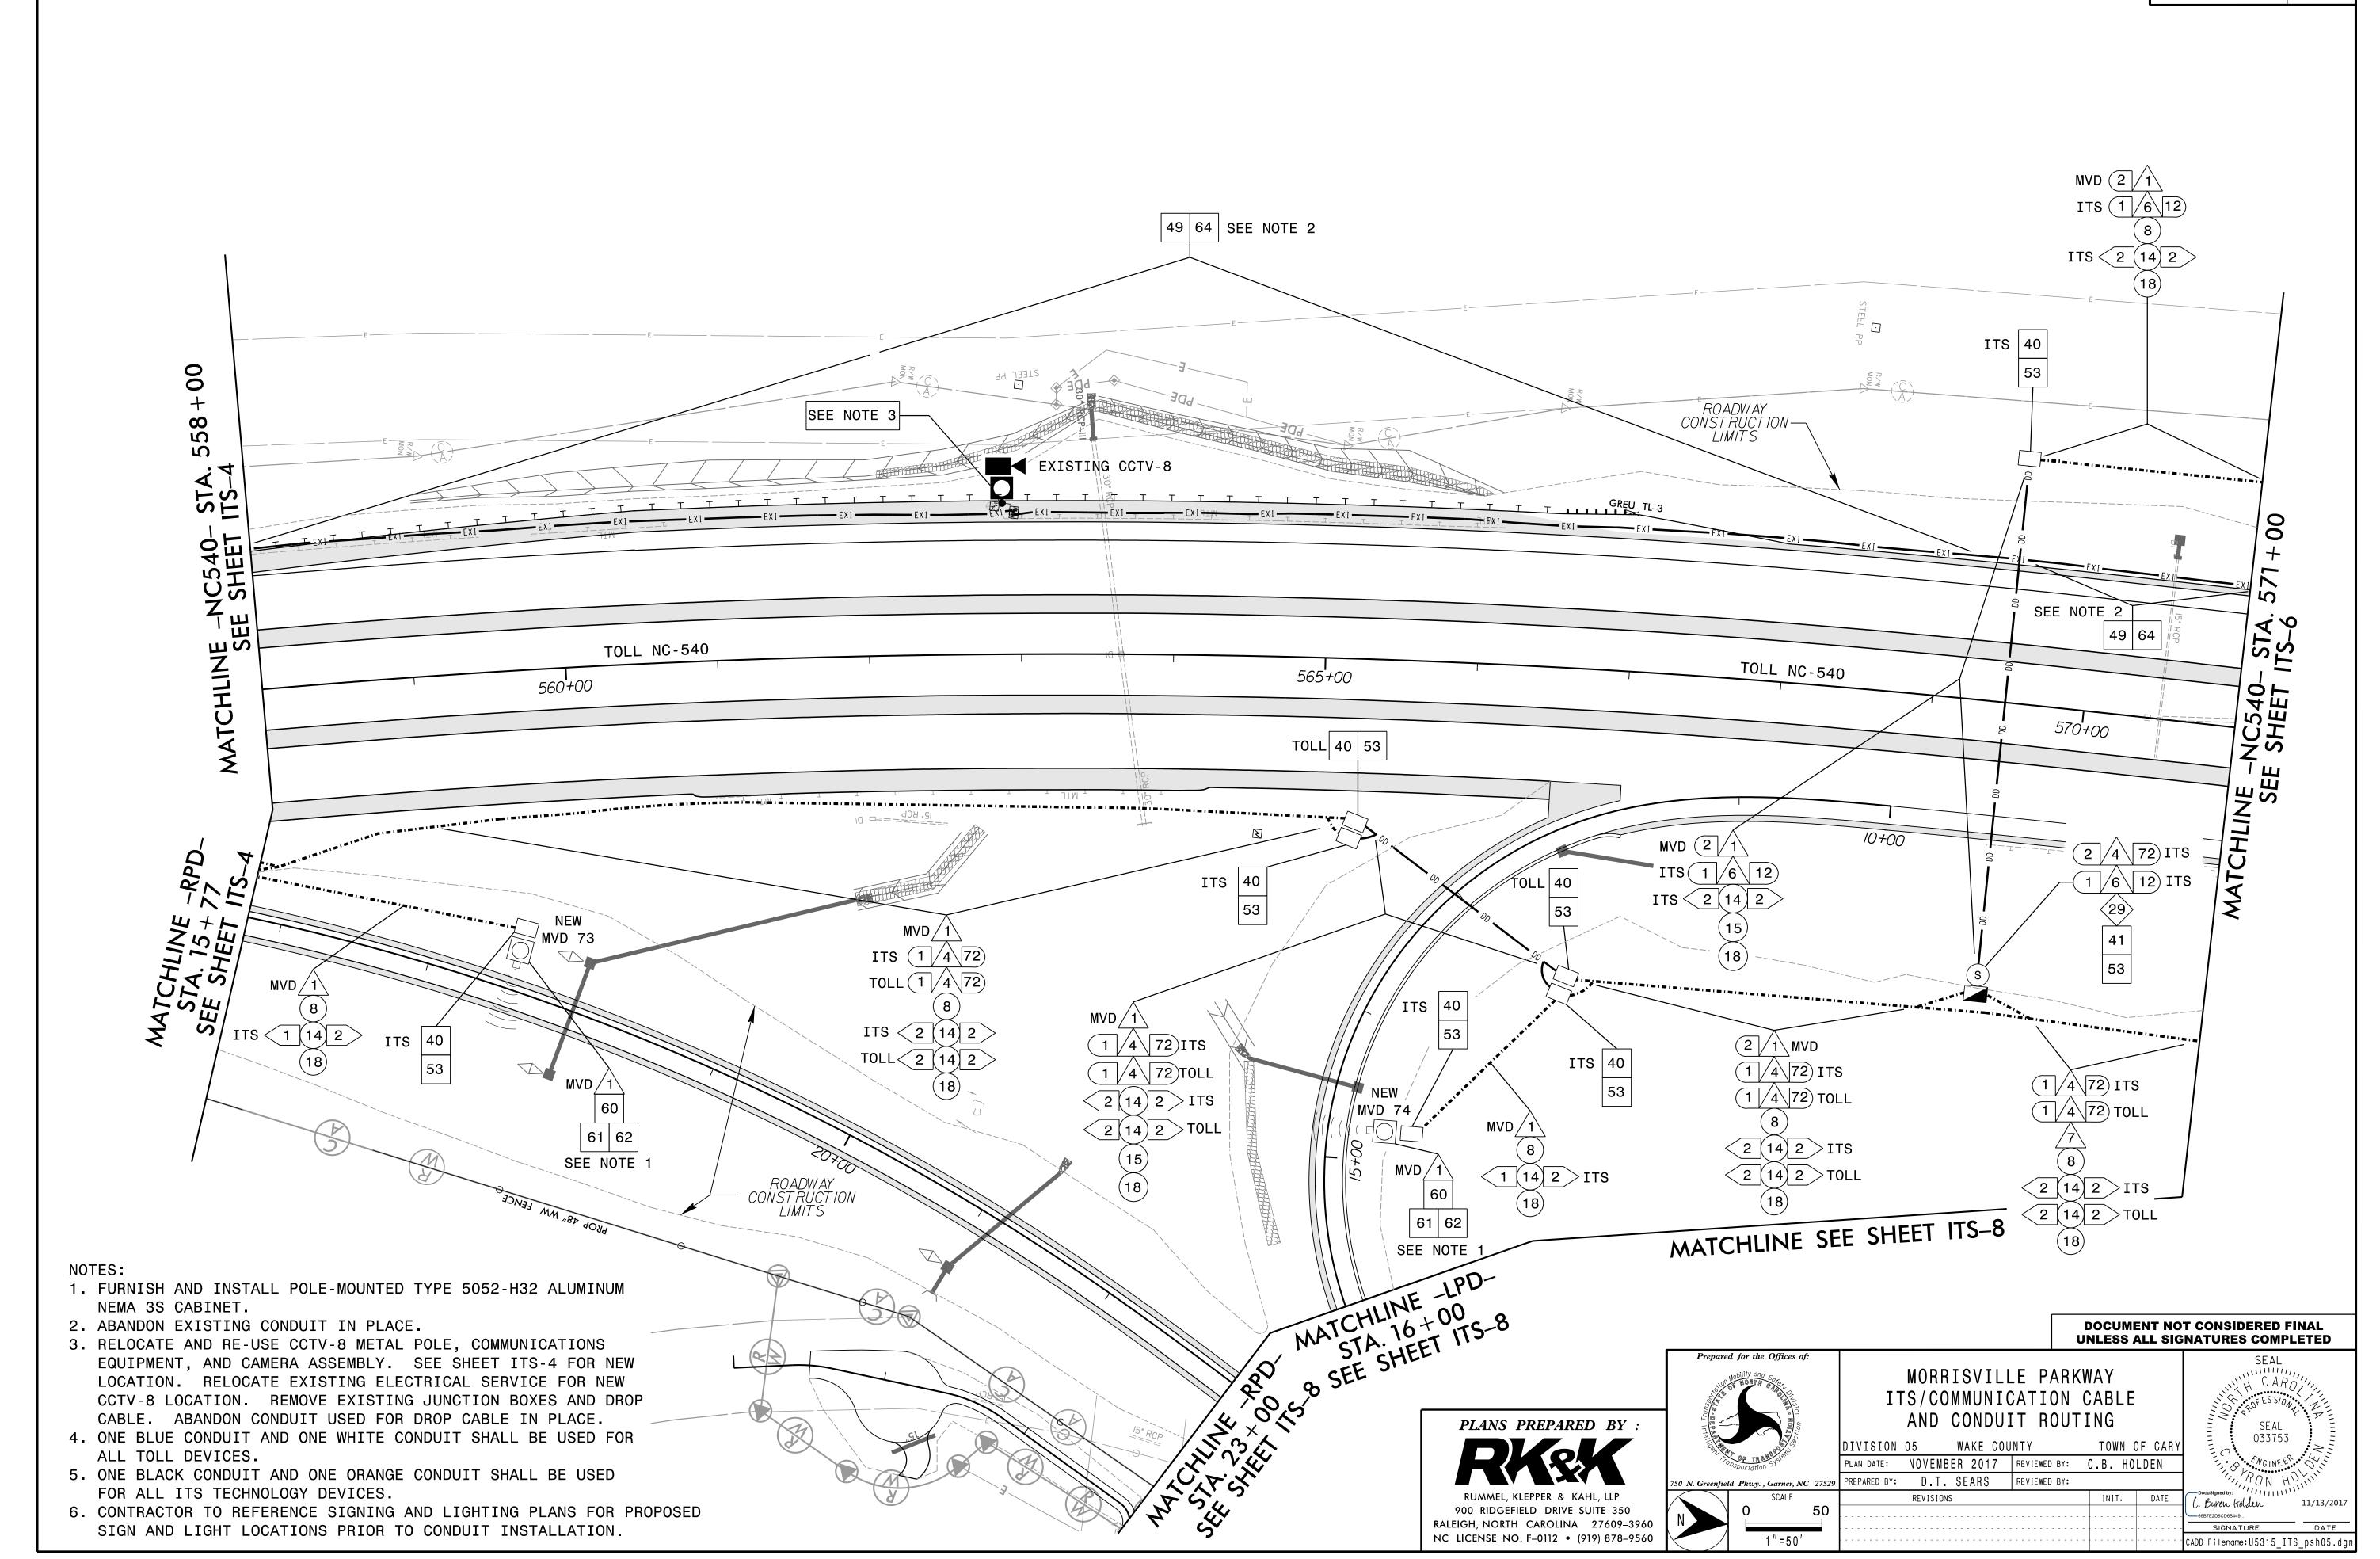

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PROJECT REFERENCE NO. U-5315 A&B

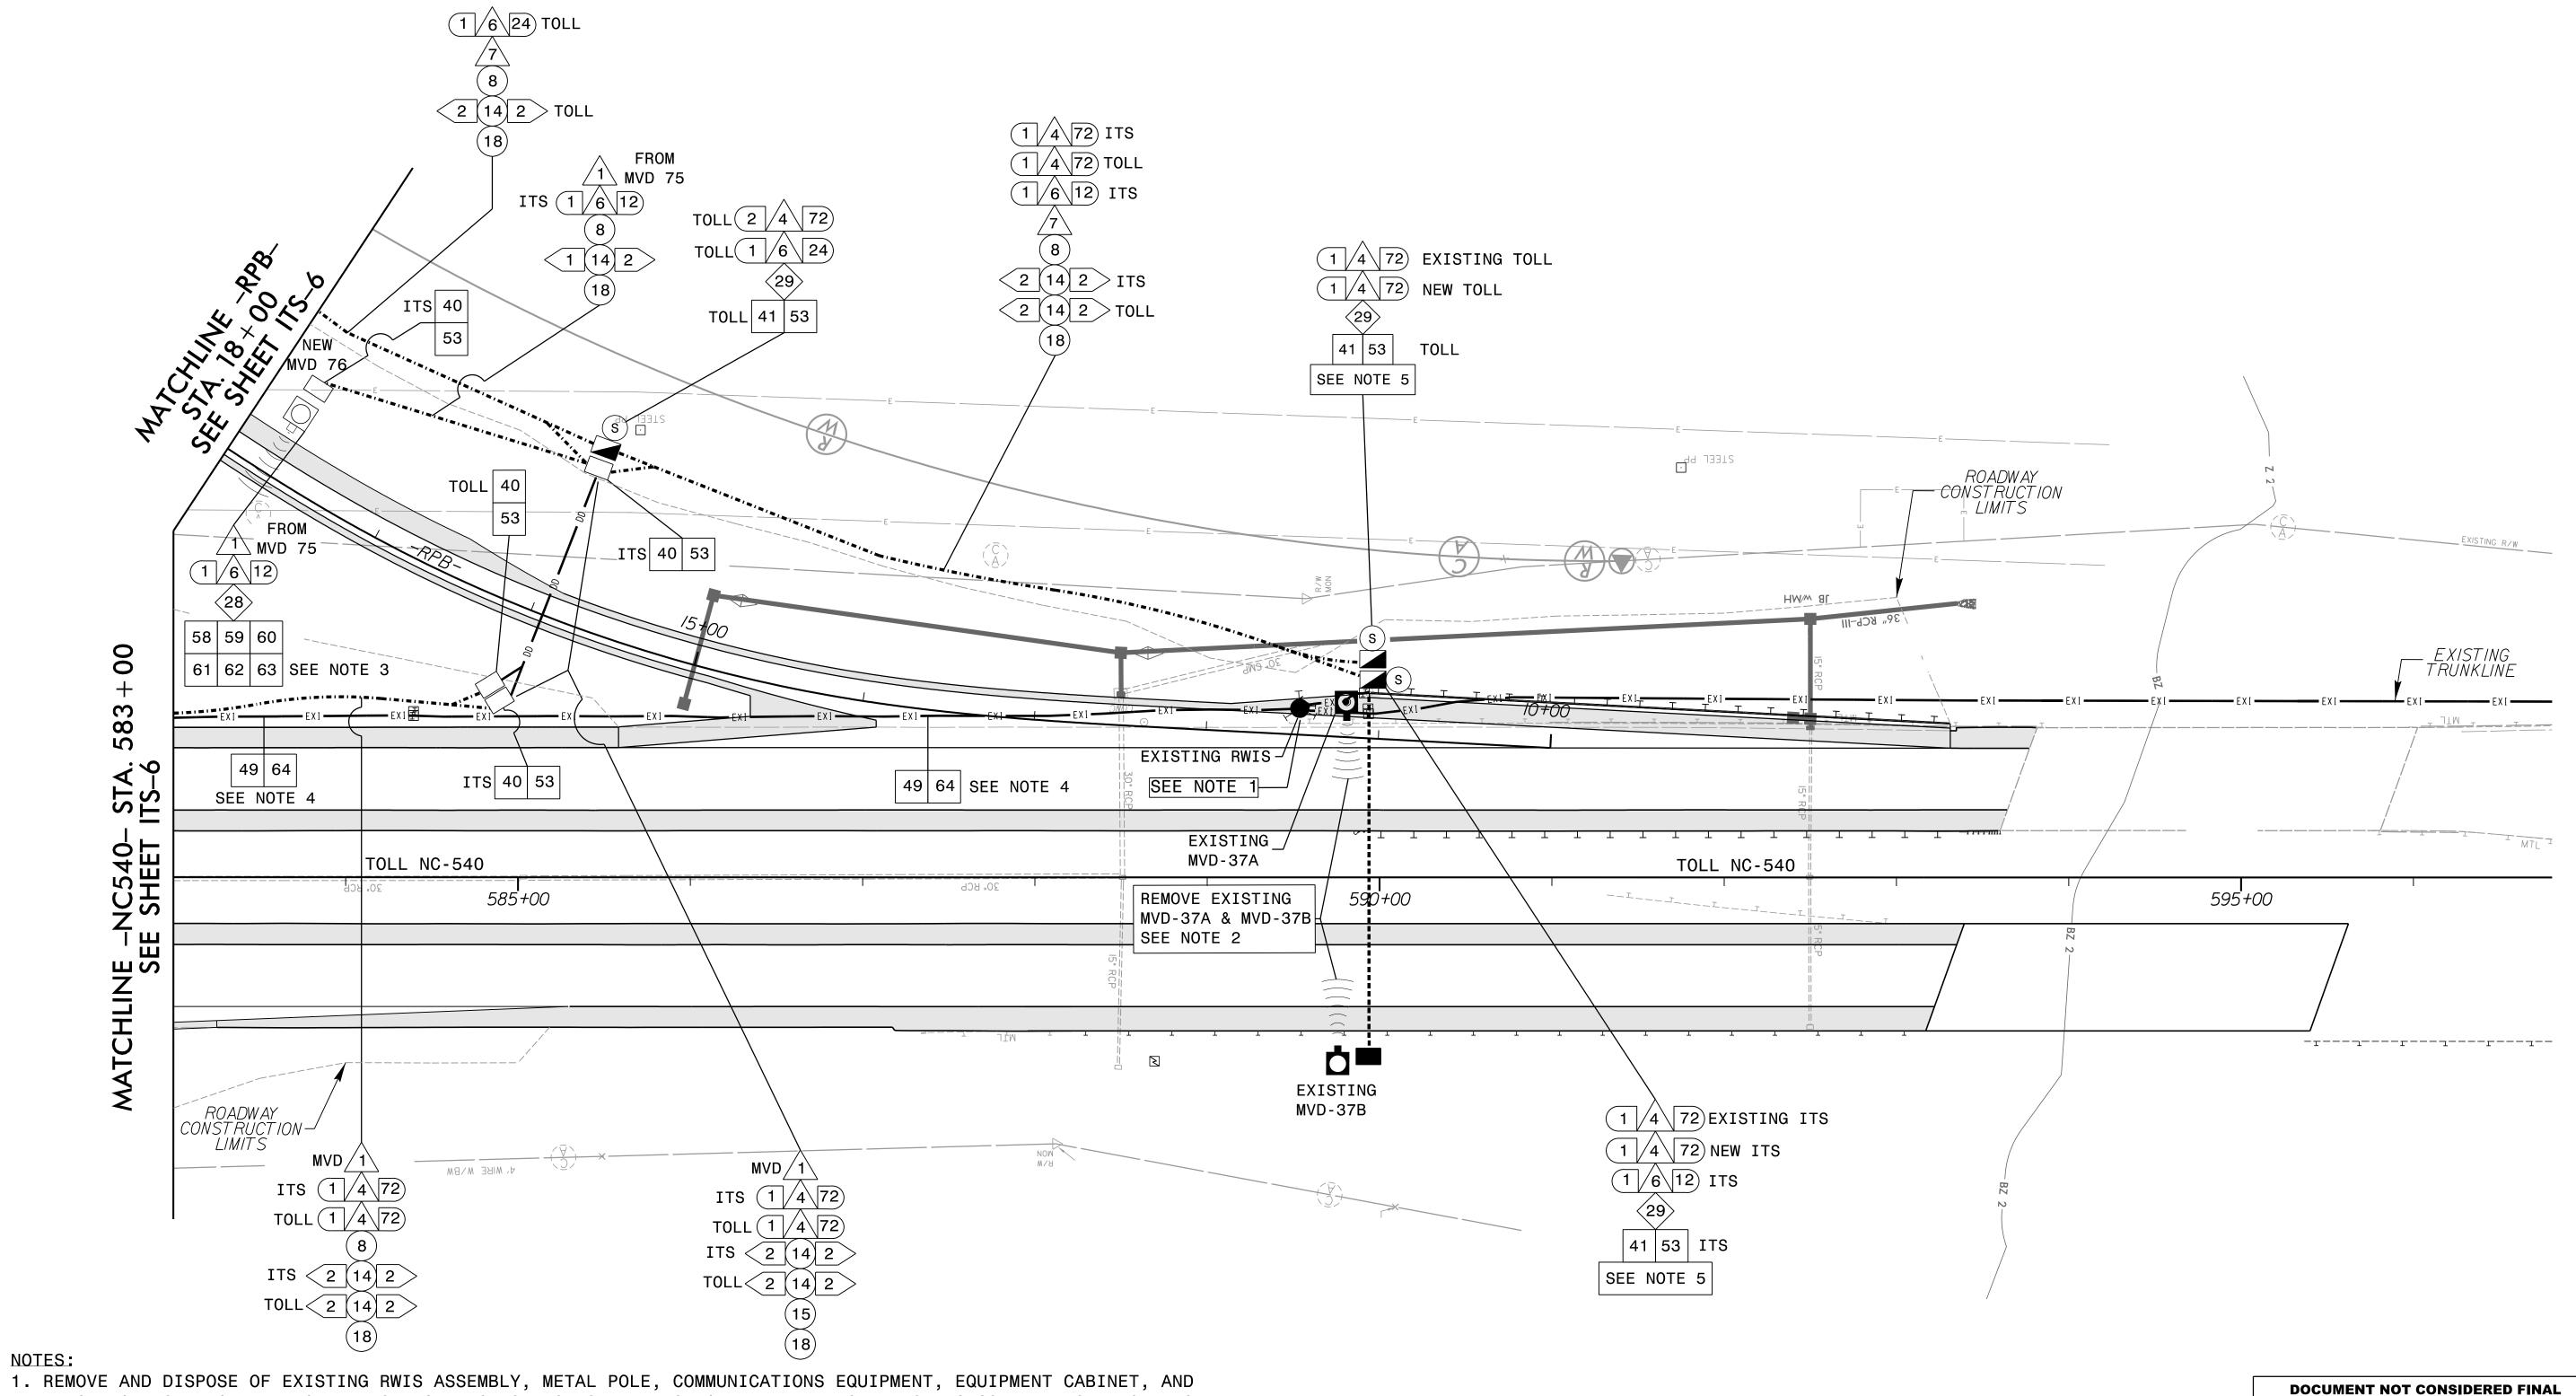

- 1. REMOVE AND DISPOSE OF EXISTING RWIS ASSEMBLY, METAL POLE, COMMUNICATIONS EQUIPMENT, EQUIPMENT CABINET, AND ELECTRICAL SERVICE. REMOVE EXISTING JUNCTION BOXES AND DROP CABLE. ABANDON EXISTING CONDUIT USED FOR DROP CABLE IN PLACE.
- 2. CONTRACTOR SHALL DELIVER MVD SENSOR, POLE, AND CABINET TO SITE DESIGNATED BY NCTA FOR STORAGE. THE METAL POLE FOUNDATION FOR MVD-37B ONLY, MAY REMAIN IN PLACE.
- 3. FURNISH AND INSTALL POLE-MOUNTED TYPE 336 CABINET.
- 4. ABANDON EXISTING CONDUIT IN PLACE.
- 5. INTERCEPT EXISTING ITS TRUNKLINE AND SPLICE TO NEW 72-FIBER ITS TRUNKLINE. INTERCEPT EXISTING TOLL TRUNKLINE AND SPLICE TO NEW 72-FIBER TOLL TRUNKLINE. SEE SHEET ITS-3D FOR DETAILS.
- 6. ONE BLUE CONDUIT AND ONE WHITE CONDUIT SHALL BE USED FOR ALL TOLL DEVICES.
- 7. ONE BLACK CONDUIT AND ONE ORANGE CONDUIT SHALL BE USED FOR ALL ITS TECHNOLOGY DEVICES.
- 8. CONTRACTOR TO REFERENCE SIGNING AND LIGHTING PLANS FOR PROPOSED SIGN AND LIGHT LOCATIONS PRIOR TO CONDUIT INSTALLATION.

PLANS PREPARED BY : RUMMEL, KLEPPER & KAHL, LLP 900 RIDGEFIELD DRIVE SUITE 350

RALEIGH, NORTH CAROLINA 27609-3960 NC LICENSE NO. F-0112 • (919) 878-9560

MORRISVILLE PARKWAY ITS/COMMUNICATION CABLE DIVISION 05 WAKE COUNTY


AND CONDUIT ROUTING 50 N. Greenfield Pkwy., Garner, NC 27529 PREPARED BY: D.T. SEARS REVIEWED BY:


TOWN OF CARY PLAN DATE: DECEMBER 2017 REVIEWED BY: C.B. HOLDEN REVISIONS INIT. DATE

033753 . Byron Holden 12/10/2017 CADD Filename: U5315 ITS psh07.dg

UNLESS ALL SIGNATURES COMPLETED

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CCTV-8

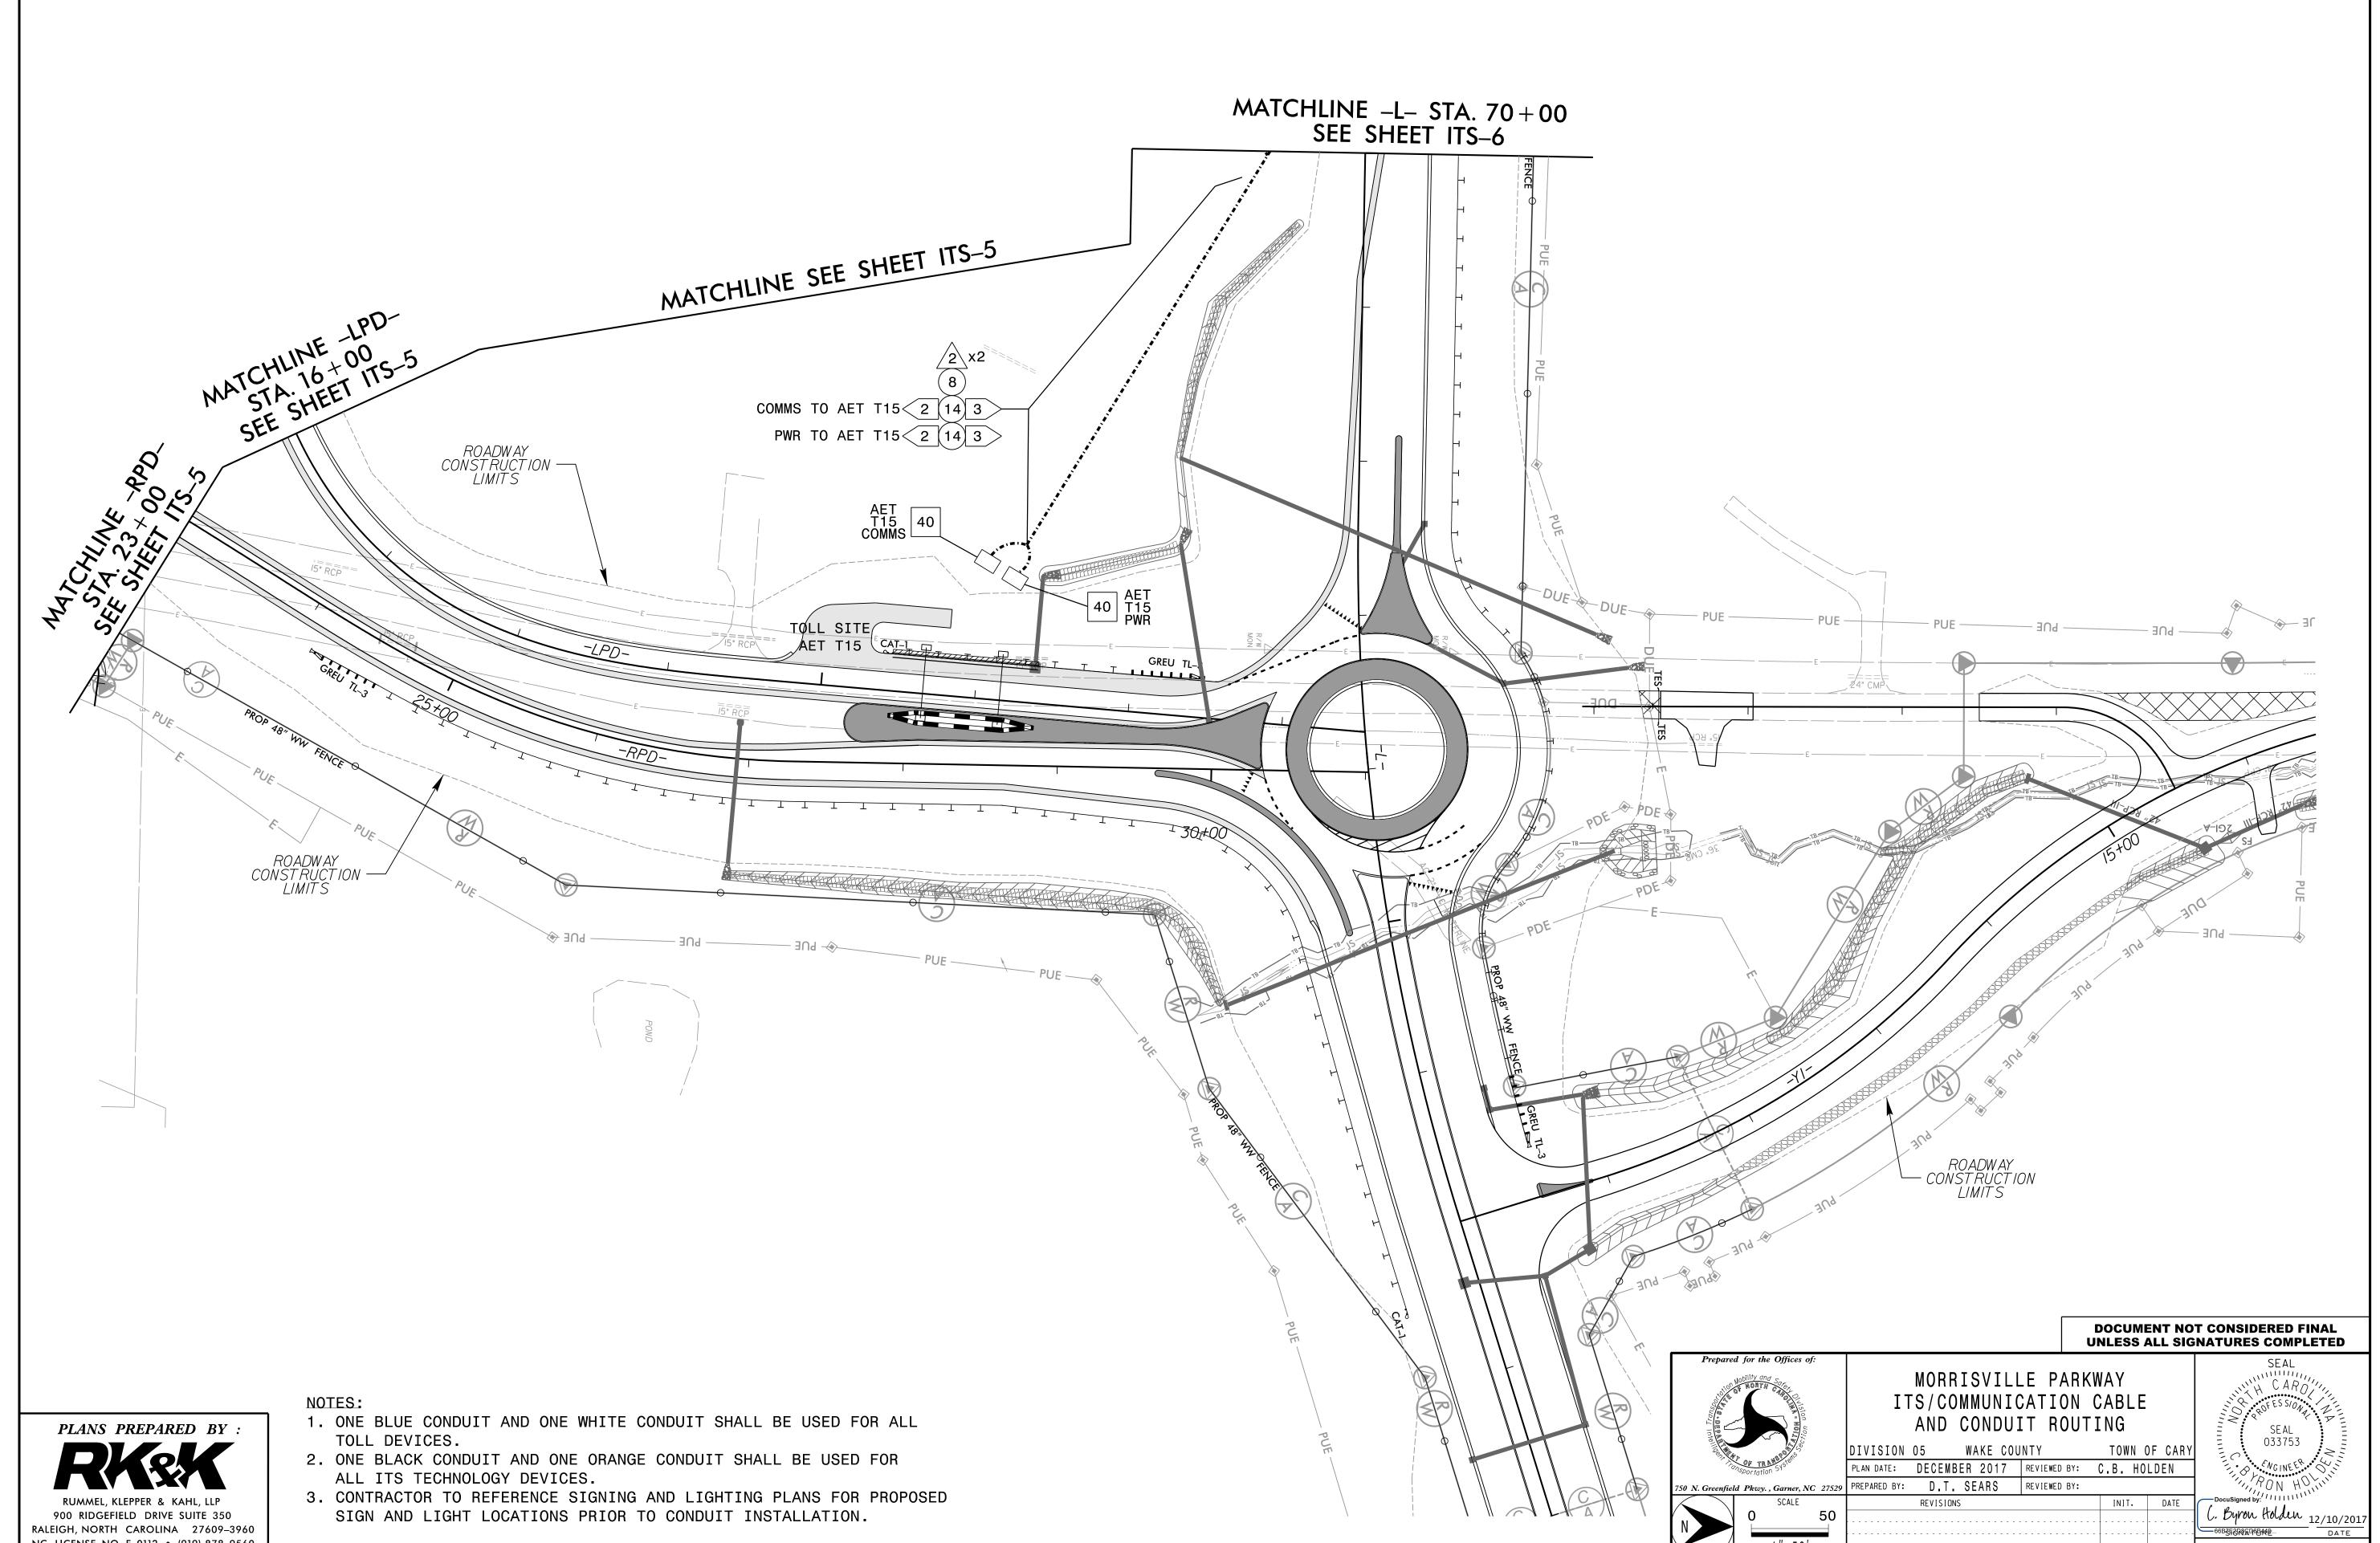TX RX TX RX

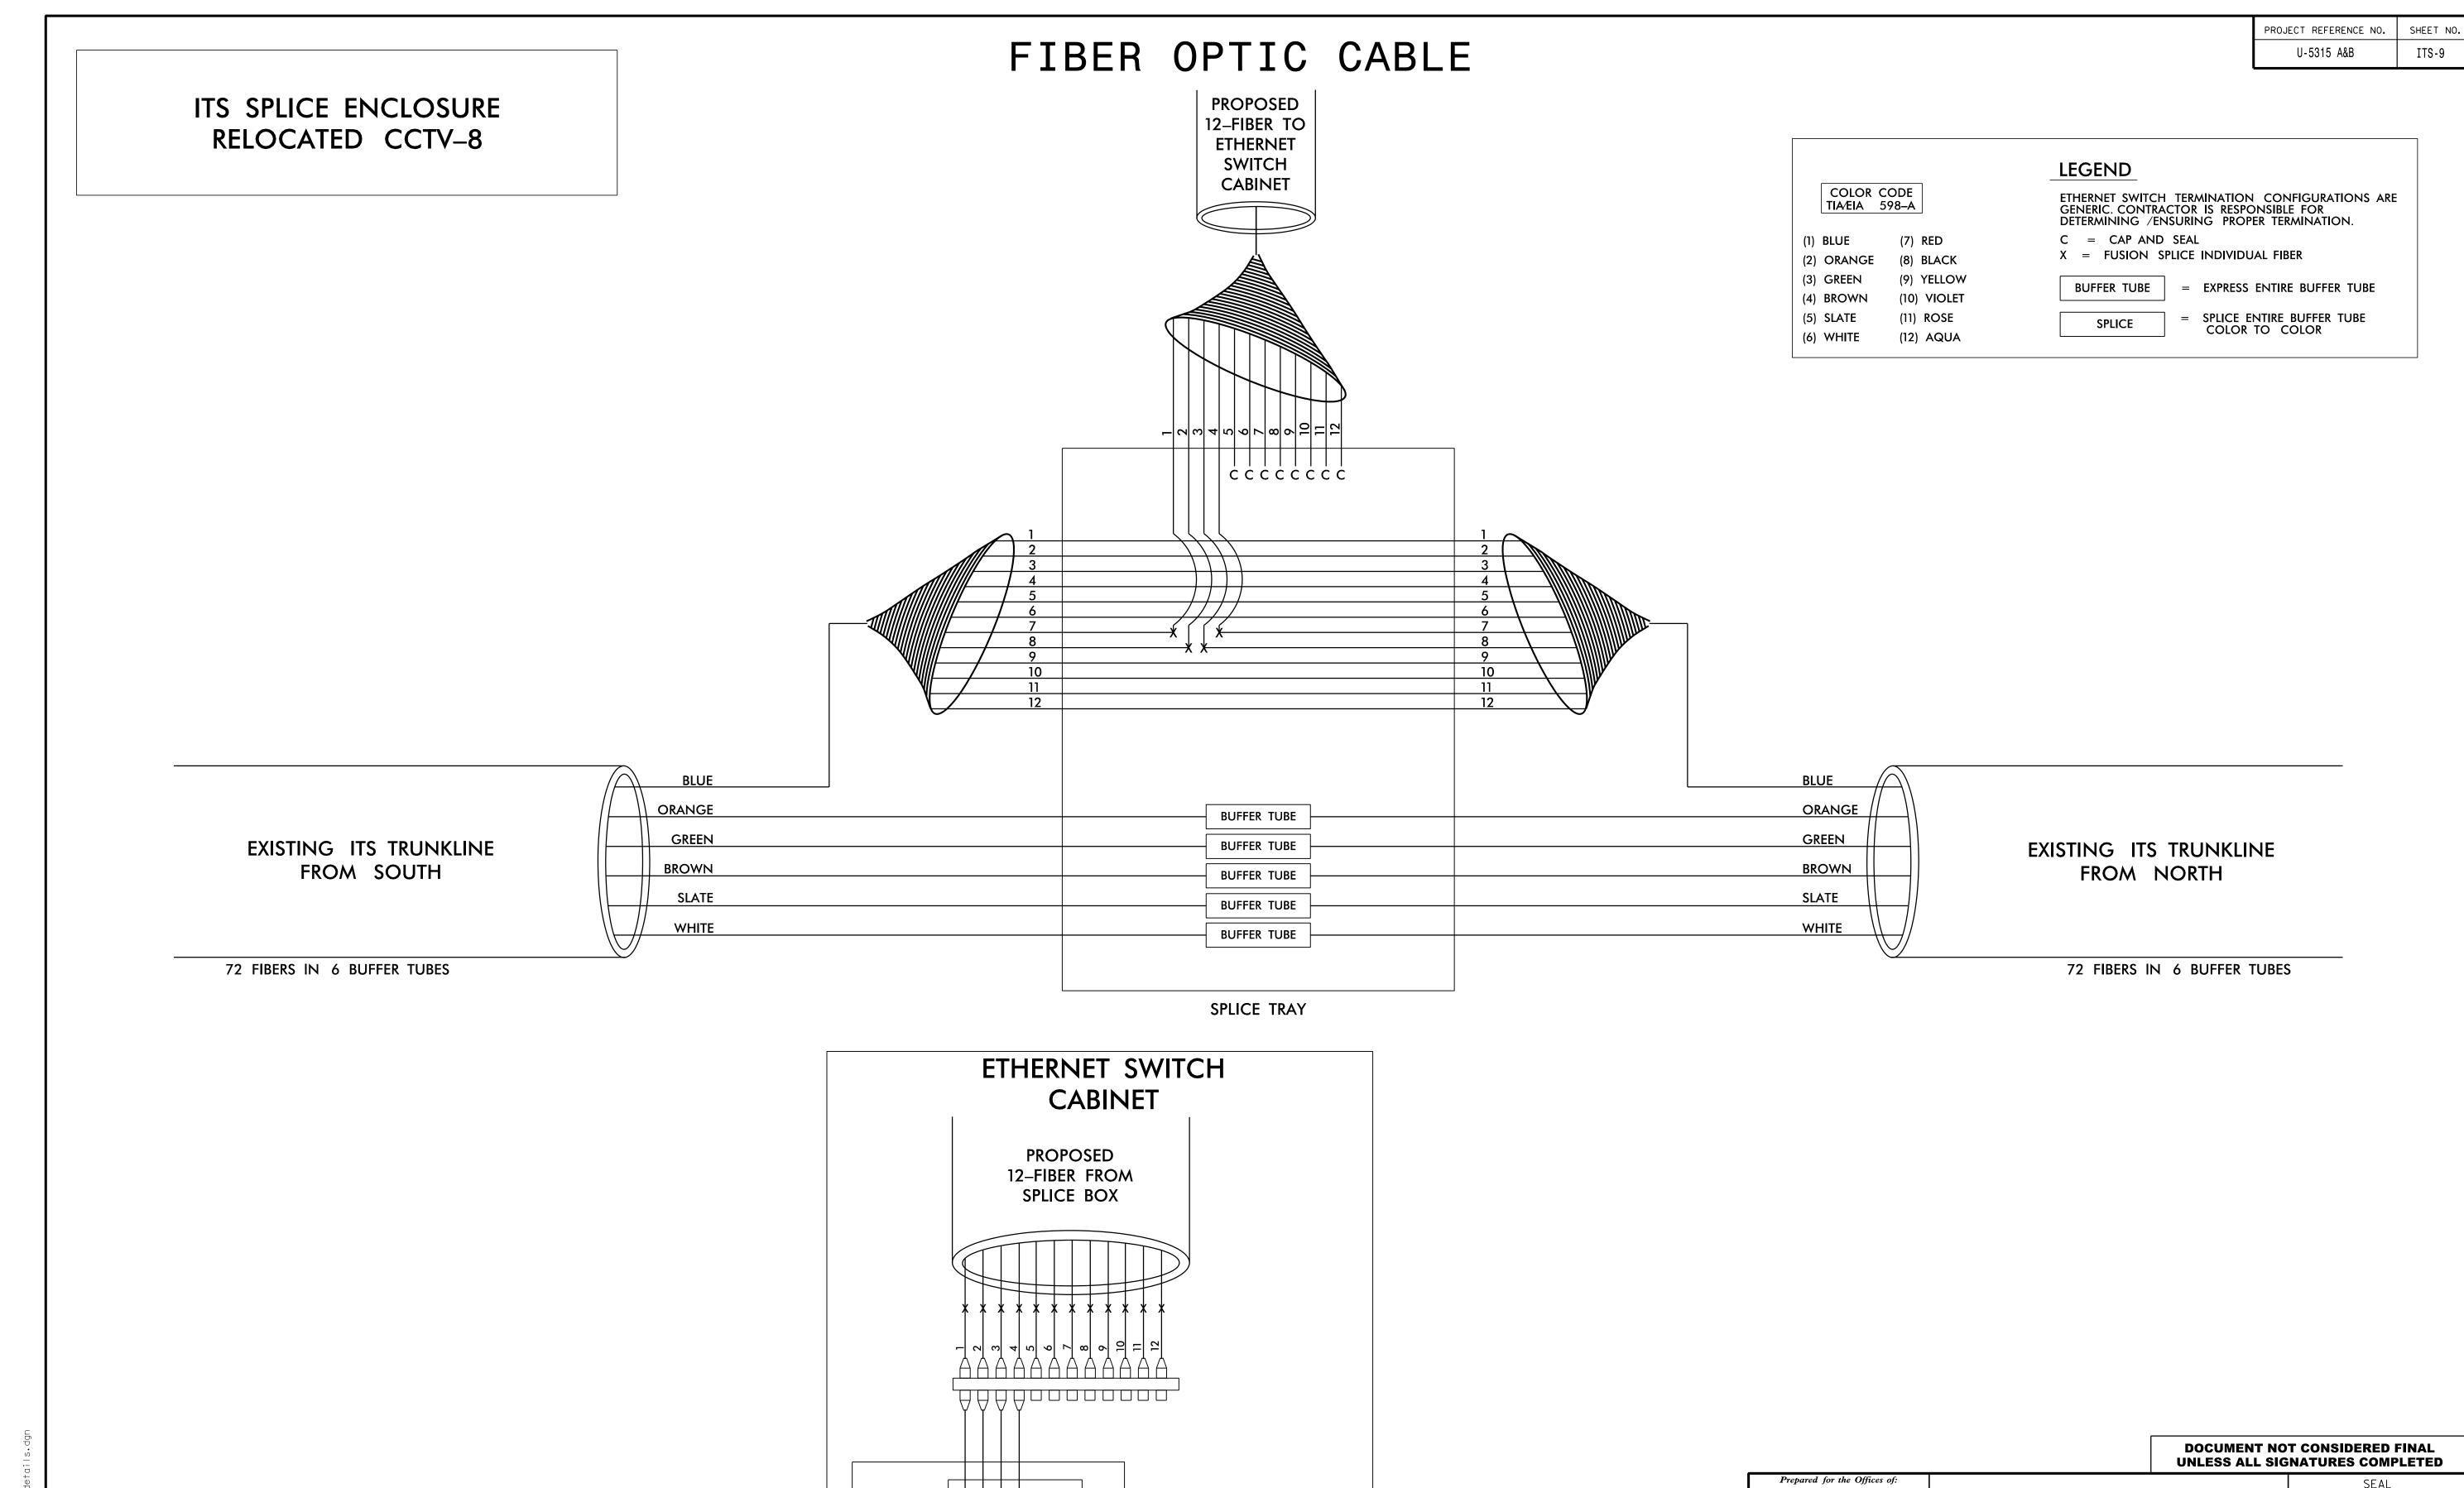1 2 2 1

ETHERNET

SWITCH

Q0000

NOTES:

FIBER INTERCONNECT CENTER RACKS ARE SCHEMATIC ONLY, ACTUAL EQUIPMENT FORM MAY VARY.
 ORANGE, GREEN, BROWN, SLATE, AND WHITE BUFFER TUBES OF EXISTING TRUNKLINE ARE TO REMAIN INTACT.
 CONTRACTOR MAY PROVIDE 6-FIBER DROP CABLES IN LIEU OF 12-FIBER AND MAY PROVIDE 6-FIBER PRE-TERMINATED DROP CABLES IN LIEU OF DROP CABLES AND INTERCONNECT CENTER.

PLANS PREPARED BY: RUMMEL, KLEPPER & KAHL, LLP 900 RIDGEFIELD DRIVE SUITE 350 RALEIGH, NORTH CAROLINA 27609–3960 NC LICENSE NO. F-0112 • (919) 878-9560



MORRISVILLE PARKWAY SPLICE DETAILS


DIVISION 05 WAKE COUNTY TOWN OF CARY PLAN DATE: NOVEMBER 2017 REVIEWED BY: C.B. HOLDEN PREPARED BY: D.T. SEARS REVIEWED BY: REVISIONS

033753 . Byron Holden

11/13/2017

N/A

CADD Filename: U5315_ITS_splicedetails dg

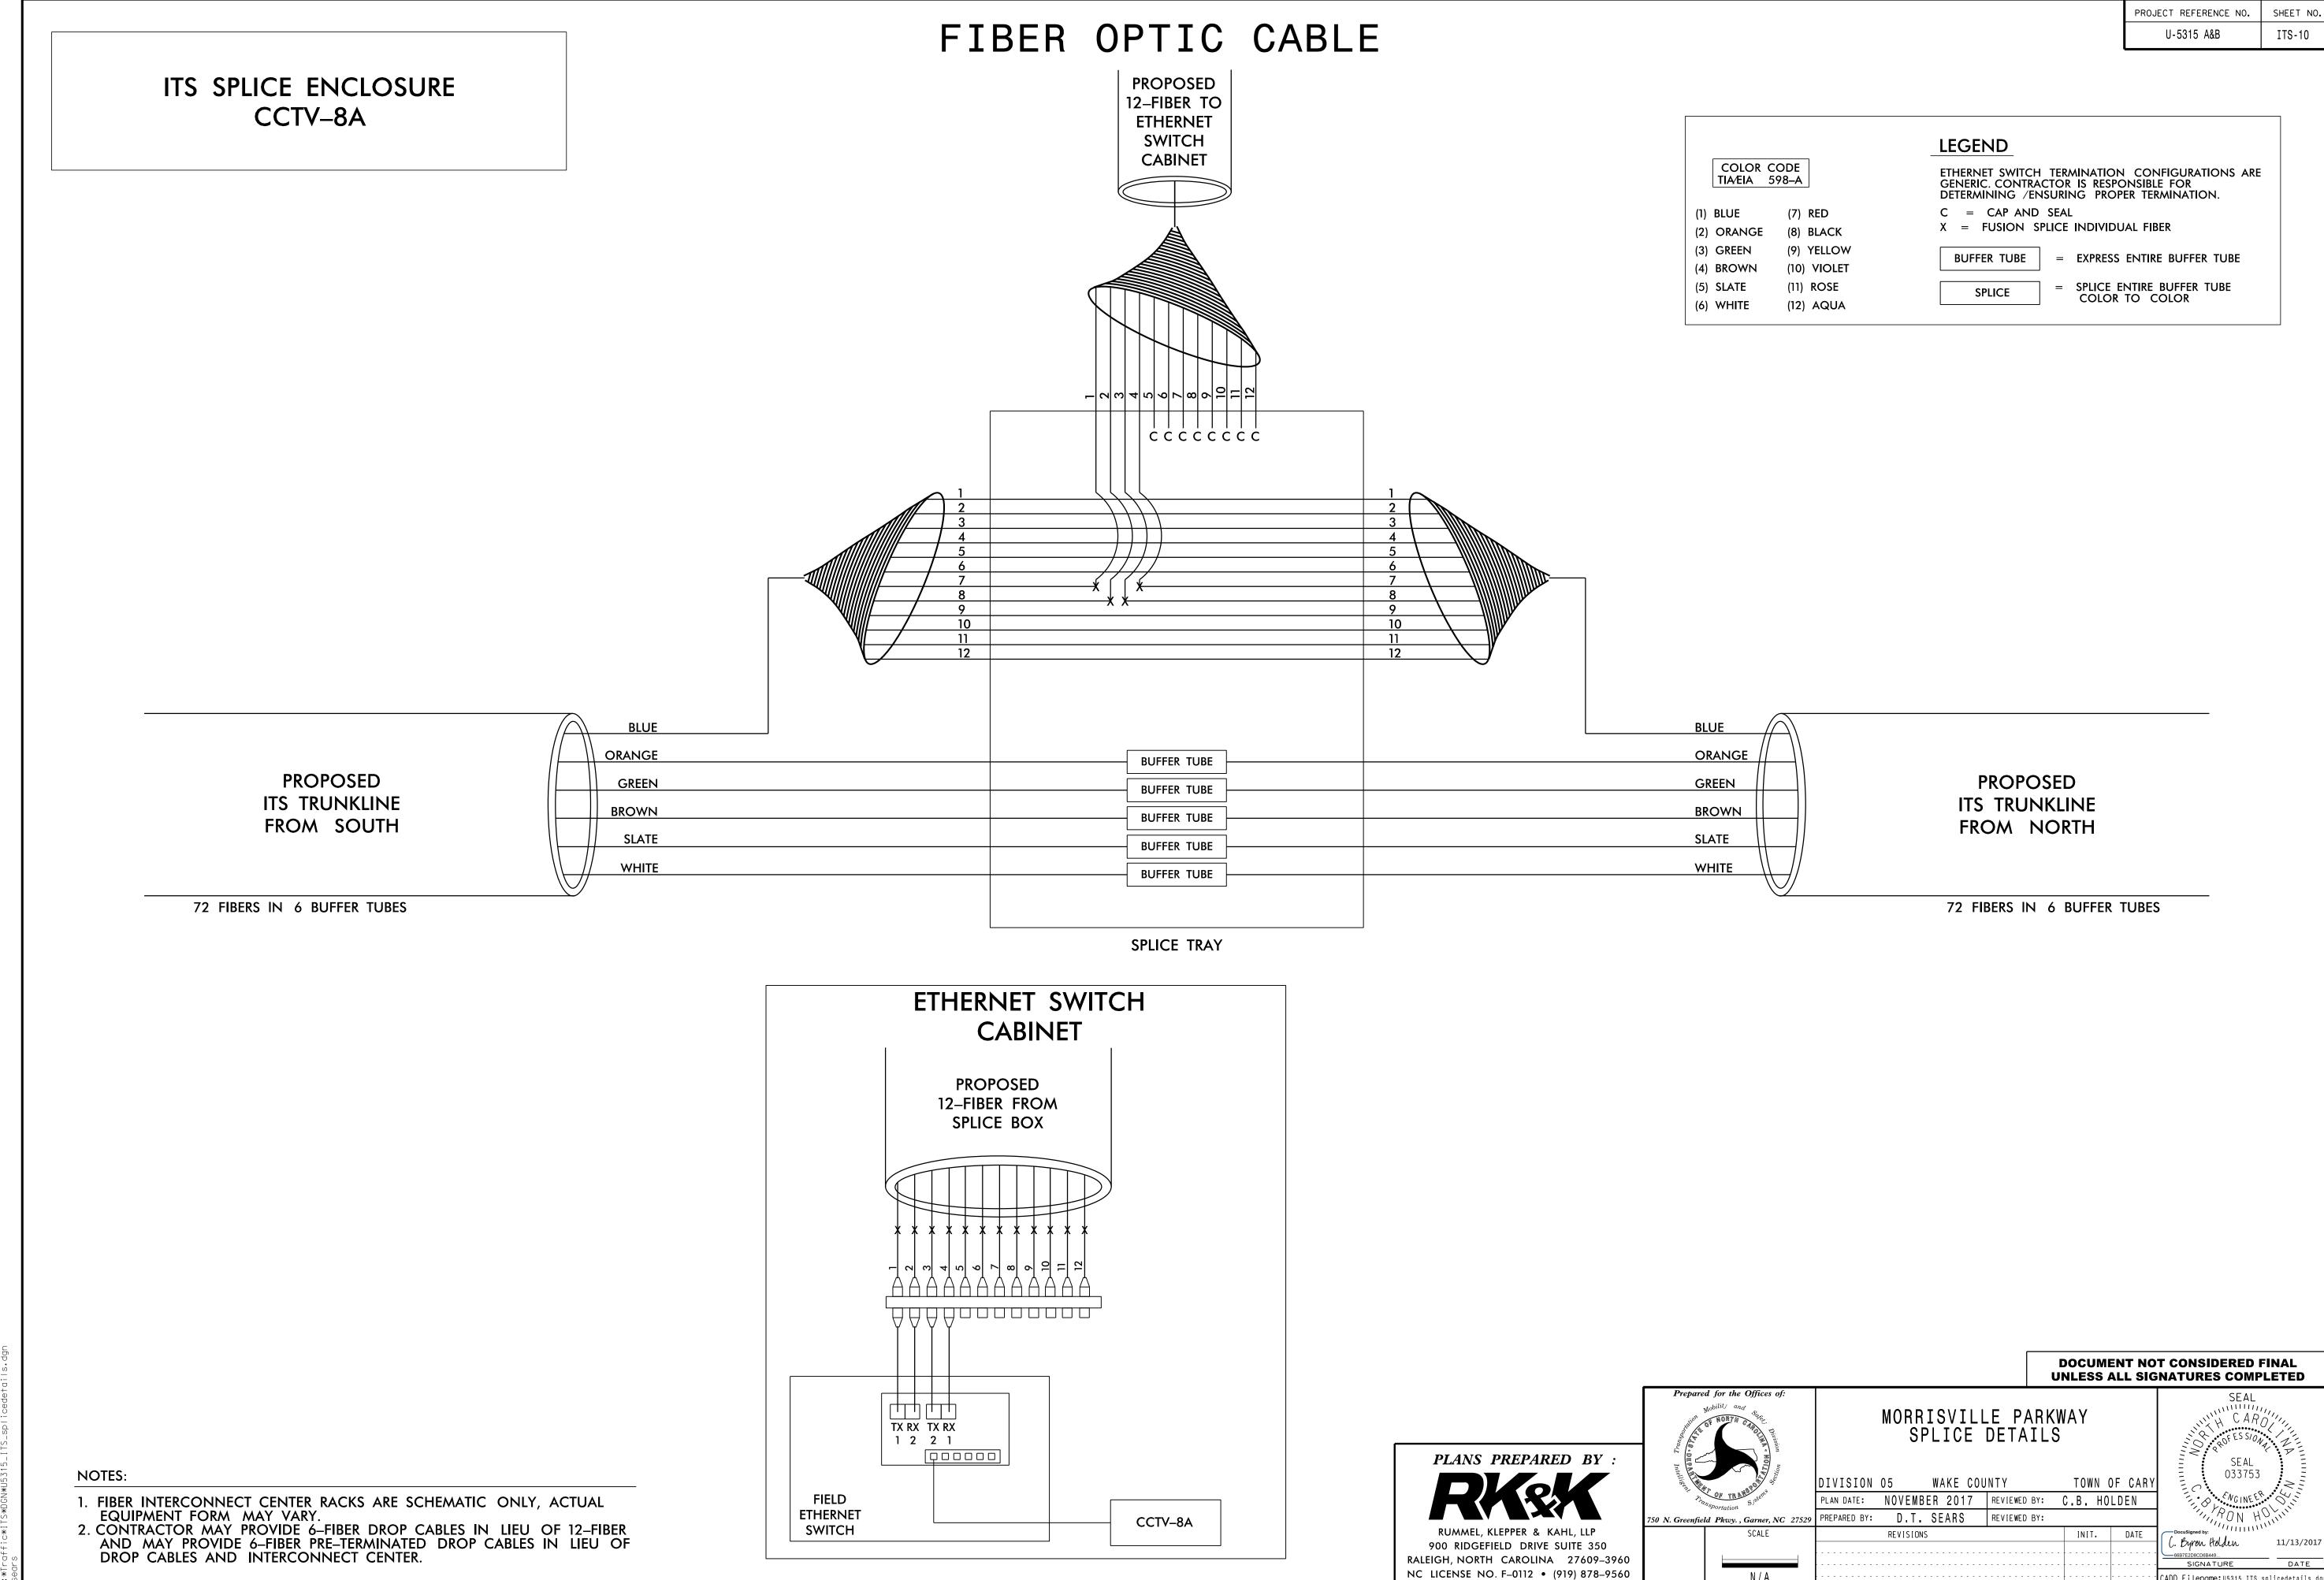

N/A

CADD Filename:U5315_ITS_splicedetails.dg

FIBER OPTIC CABLE

PROJECT REFERENCE NO. U-5315 A&B ITS-11

COLOR CODE TIA/EIA 598-A

(1) BLUE (2) ORANGE (8) BLACK (3) GREEN (9) YELLOW

(10) VIOLET

(5) SLATE (11) ROSE (6) WHITE (12) AQUA

(4) BROWN

LEGEND

ETHERNET SWITCH TERMINATION CONFIGURATIONS ARE GENERIC. CONTRACTOR IS RESPONSIBLE FOR DETERMINING /ENSURING PROPER TERMINATION.

C = CAP AND SEAL

X = FUSION SPLICE INDIVIDUAL FIBER

= EXPRESS ENTIRE BUFFER TUBE

= SPLICE ENTIRE BUFFER TUBE COLOR TO COLOR SPLICE

SPLICE ORANGE ORANGE SPLICE **PROPOSED** GREEN GREEN EXISTING ITS TRUNKLINE SPLICE NEW ITS TRUNKLINE FROM SOUTH BROWN BROWN SPLICE FROM NORTH SLATE SLATE SPLICE WHITE WHITE SPLICE 72 FIBERS IN 6 BUFFER TUBES 72 FIBERS IN 6 BUFFER TUBES

SPLICE TRAY

N/A

PLANS PREPARED BY:

RUMMEL, KLEPPER & KAHL, LLP

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MORRISVILLE PARKWAY SPLICE DETAILS

DIVISION 05 WAKE COUNTY

TOWN OF CARY

DOCUMENT NOT CONSIDERED FINAL UNLESS ALL SIGNATURES COMPLETED

PLAN DATE: NOVEMBER 2017 REVIEWED BY: C.B. HOLDEN 750 N. Greenfield Pkwy., Garner, NC 27529 PREPARED BY: D.T. SEARS REVIEWED BY: CADD Filenome:U5315_ITS_splicedetails.dg

NOTES:

1. FIBER INTERCONNECT CENTER RACKS ARE SCHEMATIC ONLY, ACTUAL EQUIPMENT FORM MAY VARY.

ITS SPLICE ENCLOSURE

EXISTING TRUNKLINE

TO NEW TRUNKLINE

-NC540- STA. 557+00 LT

FIBER OPTIC CABLE

PROJECT REFERENCE NO. U-5315 A&B ITS-12

(10) VIOLET

COLOR CODE TIA/EIA 598-A

(4) BROWN

(1) BLUE (2) ORANGE (8) BLACK (3) GREEN (9) YELLOW

(5) SLATE (11) ROSE (6) WHITE (12) AQUA LEGEND

ETHERNET SWITCH TERMINATION CONFIGURATIONS ARE GENERIC. CONTRACTOR IS RESPONSIBLE FOR DETERMINING /ENSURING PROPER TERMINATION.

C = CAP AND SEAL

X = FUSION SPLICE INDIVIDUAL FIBER


= EXPRESS ENTIRE BUFFER TUBE

= SPLICE ENTIRE BUFFER TUBE COLOR TO COLOR SPLICE

SPLICE ORANGE ORANGE SPLICE **PROPOSED** GREEN GREEN EXISTING TOLL TRUNKLINE SPLICE NEW TOLL TRUNKLINE FROM SOUTH BROWN BROWN SPLICE FROM NORTH SLATE SLATE SPLICE WHITE WHITE SPLICE 72 FIBERS IN 6 BUFFER TUBES 72 FIBERS IN 6 BUFFER TUBES

SPLICE TRAY

DOCUMENT NOT CONSIDERED FINAL UNLESS ALL SIGNATURES COMPLETED

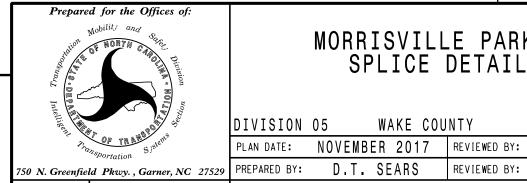

N/A

PLANS PREPARED BY:

RUMMEL, KLEPPER & KAHL, LLP

900 RIDGEFIELD DRIVE SUITE 350 RALEIGH, NORTH CAROLINA 27609–3960 NC LICENSE NO. F-0112 • (919) 878-9560

MORRISVILLE PARKWAY SPLICE DETAILS

DIVISION 05 WAKE COUNTY TOWN OF CARY PLAN DATE: NOVEMBER 2017 REVIEWED BY: C.B. HOLDEN

CADD Filenome:U5315_ITS_splicedetails.dg

TOLL SPLICE ENCLOSURE


EXISTING TRUNKLINE

TO NEW TRUNKLINE


-NC540- STA. 557+00 LT

NOTES:

1. FIBER INTERCONNECT CENTER RACKS ARE SCHEMATIC ONLY, ACTUAL EQUIPMENT FORM MAY VARY.

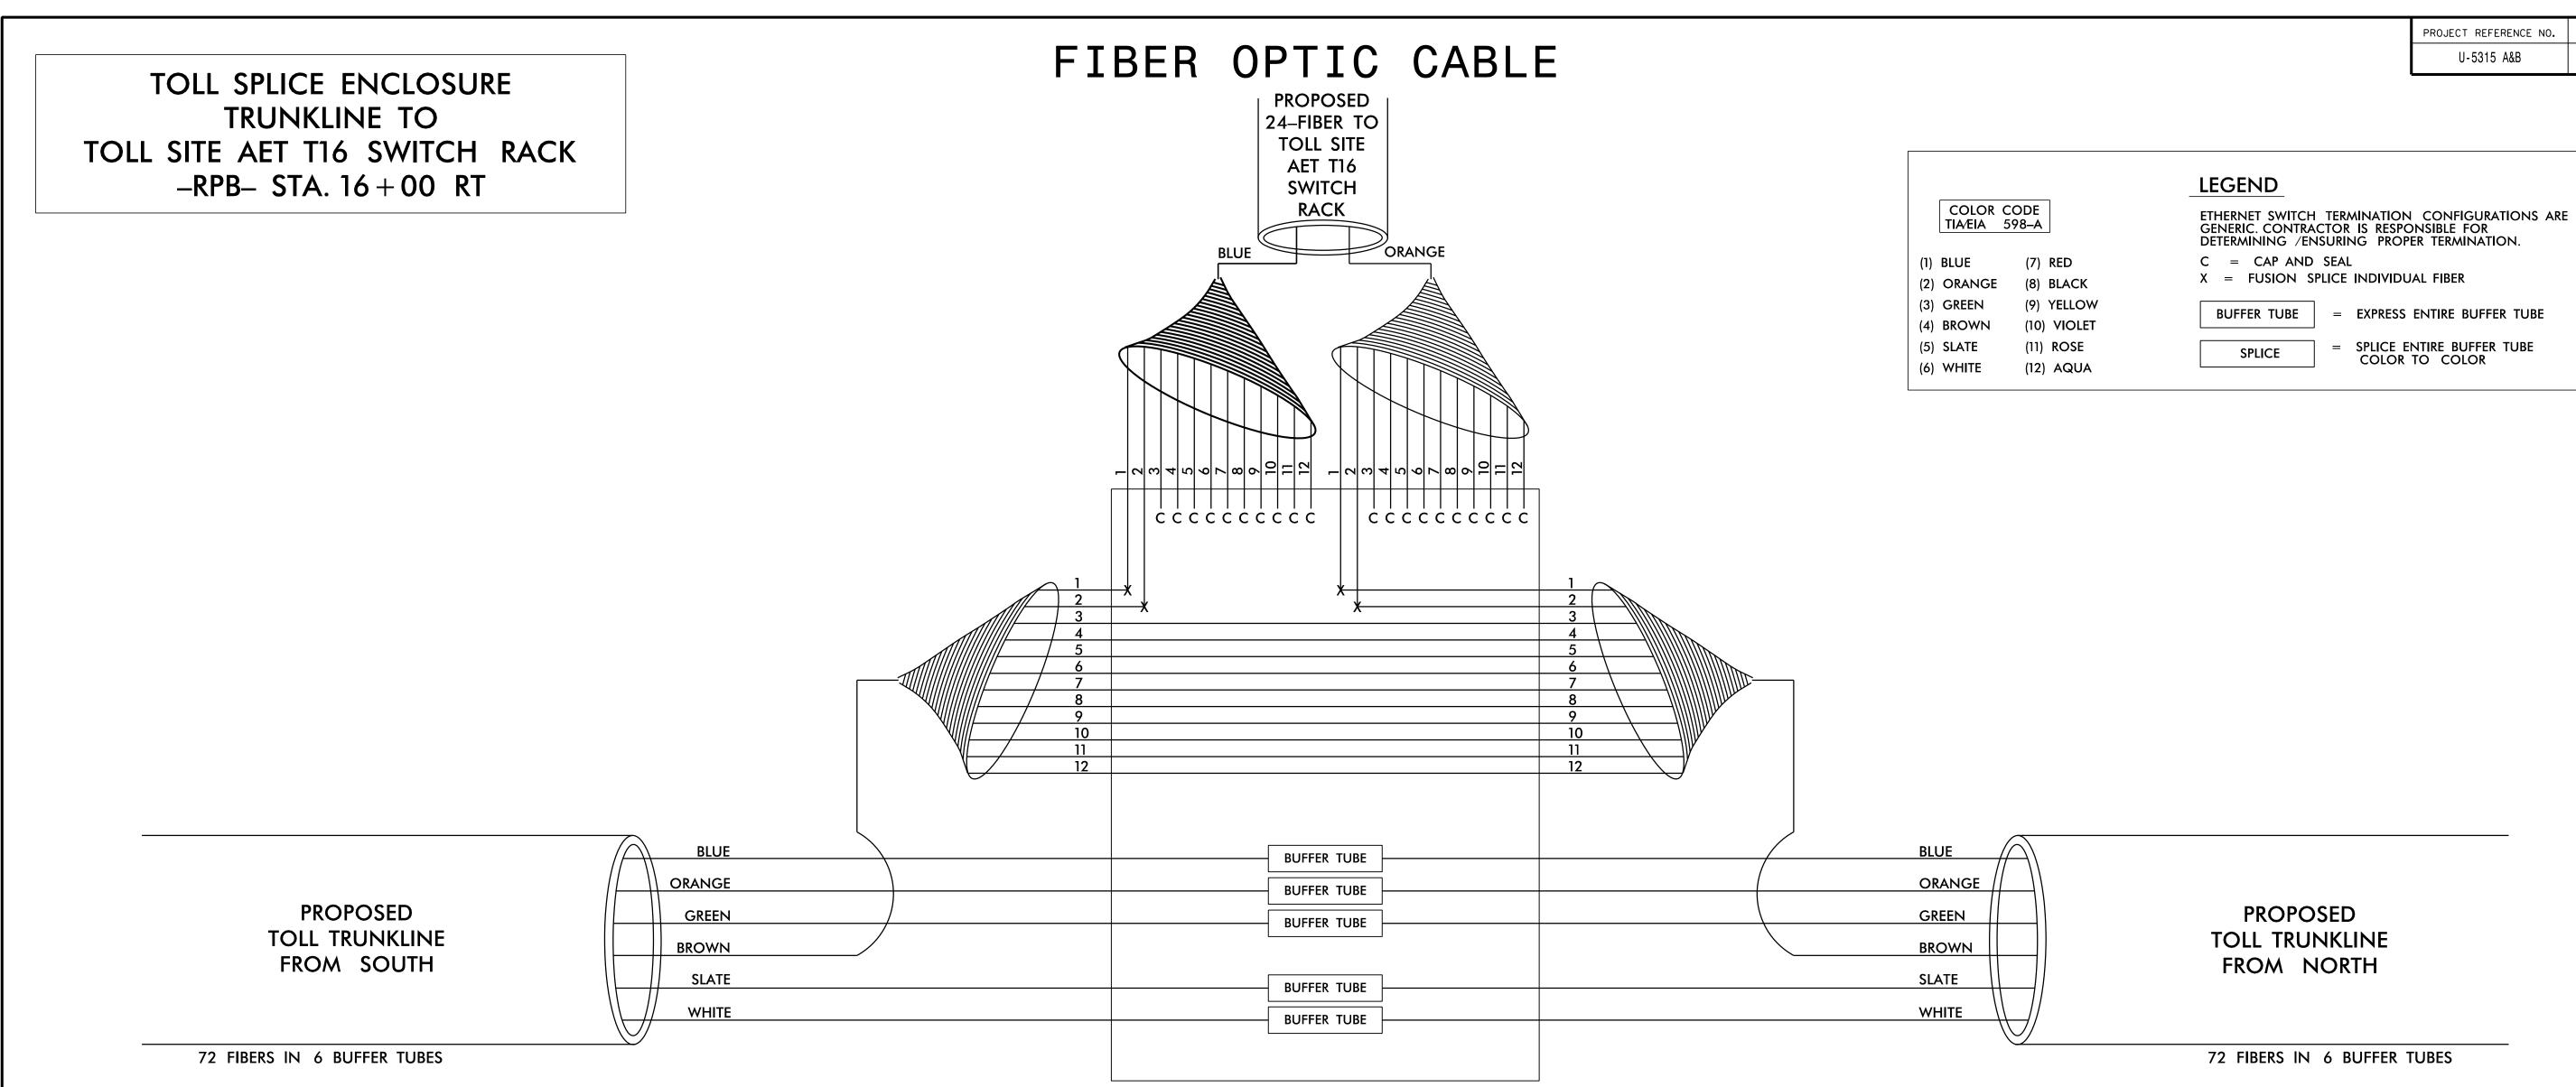

SPLICE TRAY

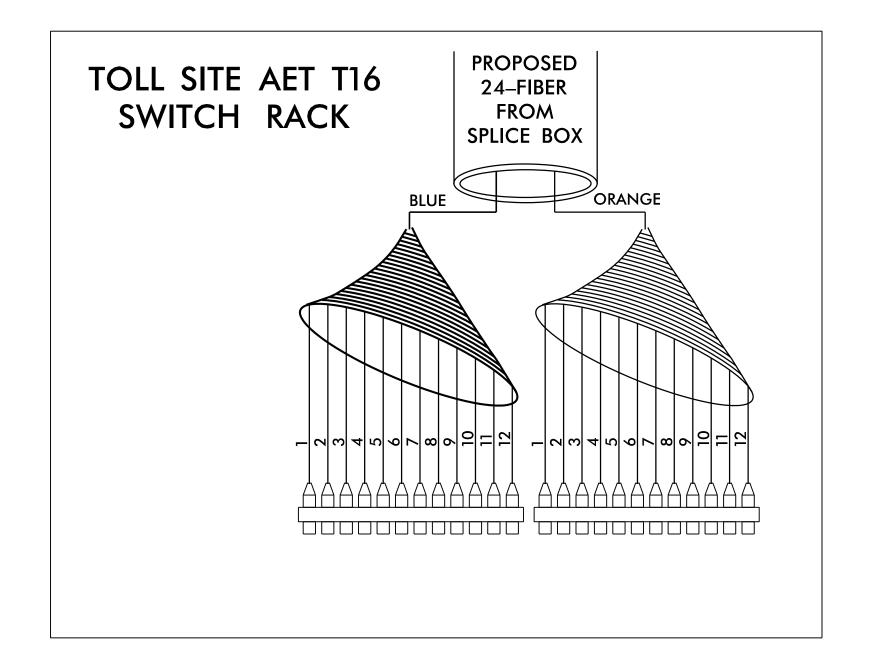

MORRISVILLE PARKWAY SPLICE DETAILS

DIVISION 05 WAKE COUNTY TOWN OF CARY

PLAN DATE: NOVEMBER 2017 REVIEWED BY: C.B. HOLDEN PREPARED BY: D.T. SEARS REVIEWED BY: REVISIONS

DOCUMENT NOT CONSIDERED FINAL **UNLESS ALL SIGNATURES COMPLETED**

ITS-13


NOTES:

1. FIBER INTERCONNECT CENTER RACKS ARE SCHEMATIC ONLY, ACTUAL EQUIPMENT FORM MAY VARY.

PLANS PREPARED BY:

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C. Byron Holden CADD Filename: U5315_ITS_splicedetails.d

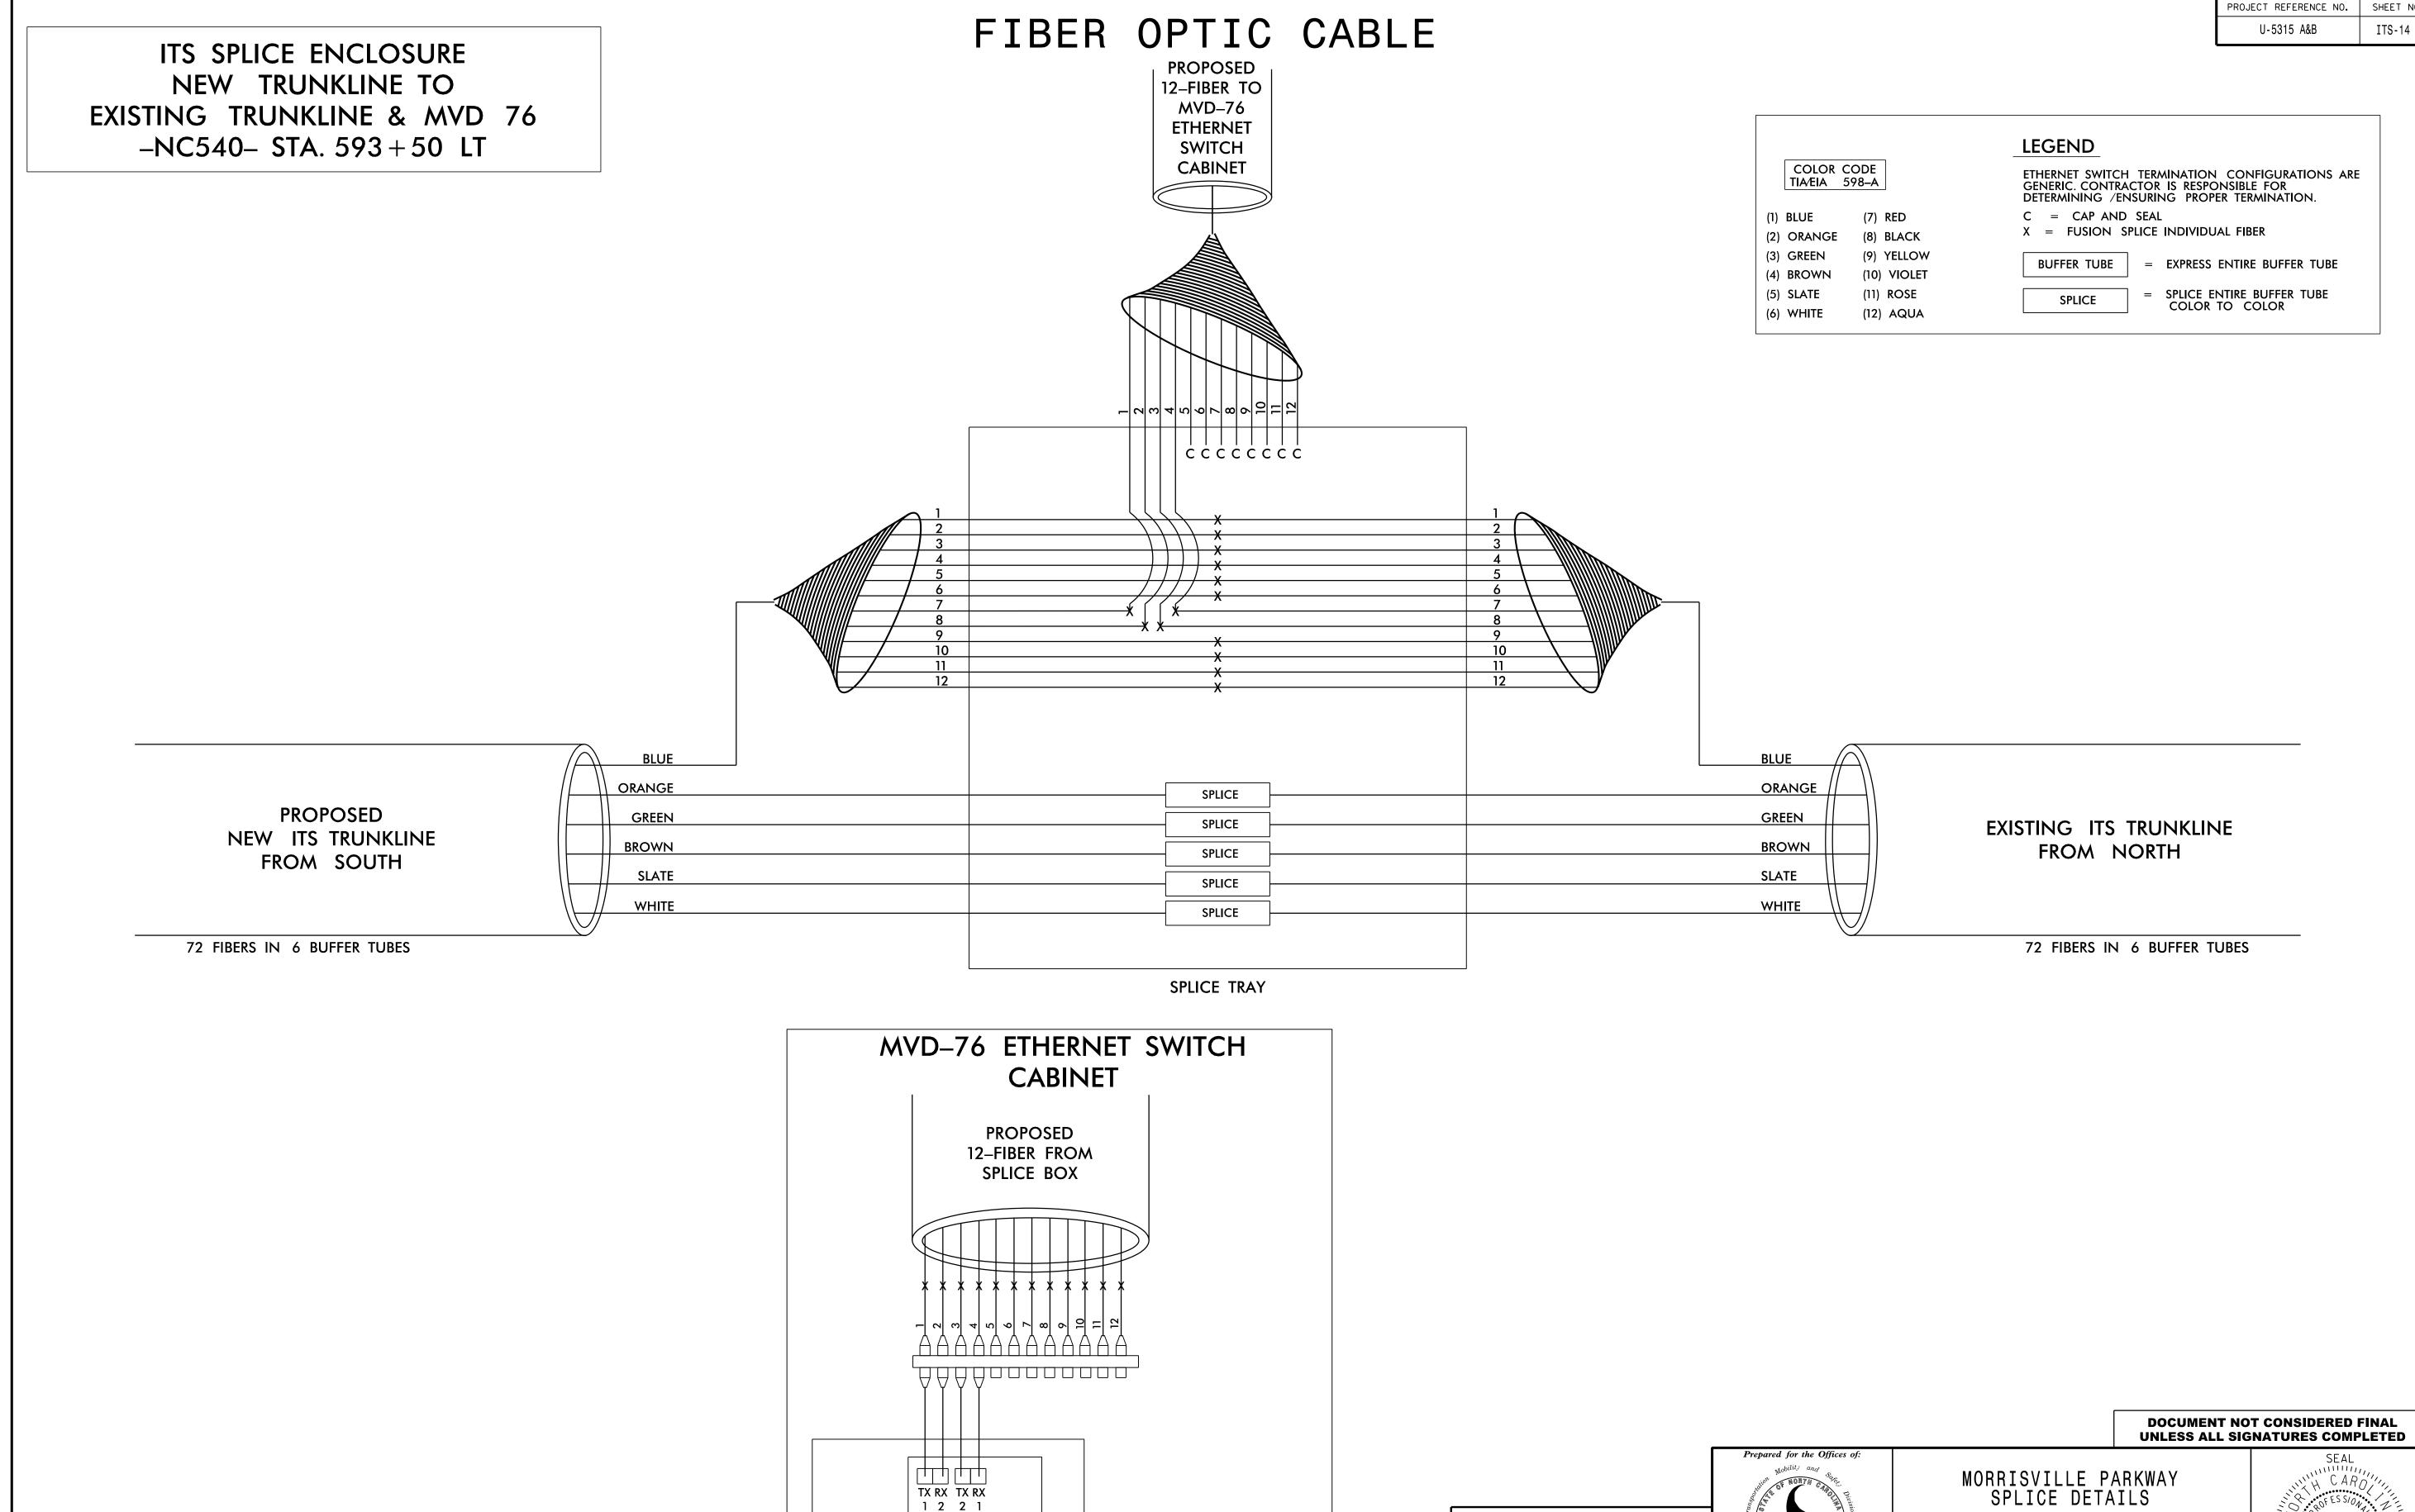

MVD 76

Q00000

FIELD

ETHERNET

SWITCH

NOTES:

FIBER INTERCONNECT CENTER RACKS ARE SCHEMATIC ONLY, ACTUAL EQUIPMENT FORM MAY VARY.

2. CONTRACTOR MAY PROVIDE 6-FIBER DROP CABLES IN LIEU OF 12-FIBER AND MAY PROVIDE 6-FIBER PRE-TERMINATED DROP CABLES IN LIEU OF DROP CABLES AND INTERCONNECT CENTER.

PLANS PREPARED BY: RUMMEL, KLEPPER & KAHL, LLP 900 RIDGEFIELD DRIVE SUITE 350 RALEIGH, NORTH CAROLINA 27609-3960 NC LICENSE NO. F-0112 • (919) 878-9560



N/A

DIVISION 05 WAKE COUNTY TOWN OF CARY

PLAN DATE: DECEMBER 2017 REVIEWED BY: C.B. HOLDEN PREPARED BY: D.T. SEARS REVIEWED BY: REVISIONS

C. Byron Holden 2/10/2017 CADD Filename: U5315_ITS_splicedetails dg FIBER OPTIC CABLE

PROJECT REFERENCE NO. ITS-15 U-5315 A&B

COLOR CODE TIA/EIA 598-A

(1) BLUE (2) ORANGE (8) BLACK

(3) GREEN (9) YELLOW (4) BROWN (10) VIOLET (5) SLATE (11) ROSE

(6) WHITE (12) AQUA

LEGEND

ETHERNET SWITCH TERMINATION CONFIGURATIONS ARE GENERIC. CONTRACTOR IS RESPONSIBLE FOR DETERMINING /ENSURING PROPER TERMINATION.

C = CAP AND SEAL

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SPLICE ORANGE ORANGE SPLICE **PROPOSED** GREEN GREEN EXISTING TOLL TRUNKLINE SPLICE NEW TOLL TRUNKLINE BROWN BROWN FROM NORTH SPLICE FROM SOUTH SLATE SLATE SPLICE WHITE WHITE SPLICE 72 FIBERS IN 6 BUFFER TUBES 72 FIBERS IN 6 BUFFER TUBES

SPLICE TRAY

MORRISVILLE PARKWAY SPLICE DETAILS

DIVISION 05 WAKE COUNTY PLAN DATE: NOVEMBER 2017 REVIEWED BY: C.B. HOLDEN

TOWN OF CARY 750 N. Greenfield Pkwy., Garner, NC 27529 PREPARED BY: D.T. SEARS REVIEWED BY:

NOTES:

1. FIBER INTERCONNECT CENTER RACKS ARE SCHEMATIC ONLY, ACTUAL EQUIPMENT FORM MAY VARY.

TOLL SPLICE ENCLOSURE

NEW TRUNKLINE TO

EXISTING TRUNKLINE

-NC540- STA. 593 + 50 LT

PLANS PREPARED BY: RUMMEL, KLEPPER & KAHL, LLP

900 RIDGEFIELD DRIVE SUITE 350 RALEIGH, NORTH CAROLINA 27609–3960

NC LICENSE NO. F-0112 • (919) 878-9560

N/A

CADD Filenome:U5315_ITS_splicedetails.dg

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